
OTAL SHEET HEETS NO

BURNING BUSH LANE STREET LIGHTING

VILLAGE OF MOUNT PROSPECT, ILLINOIS

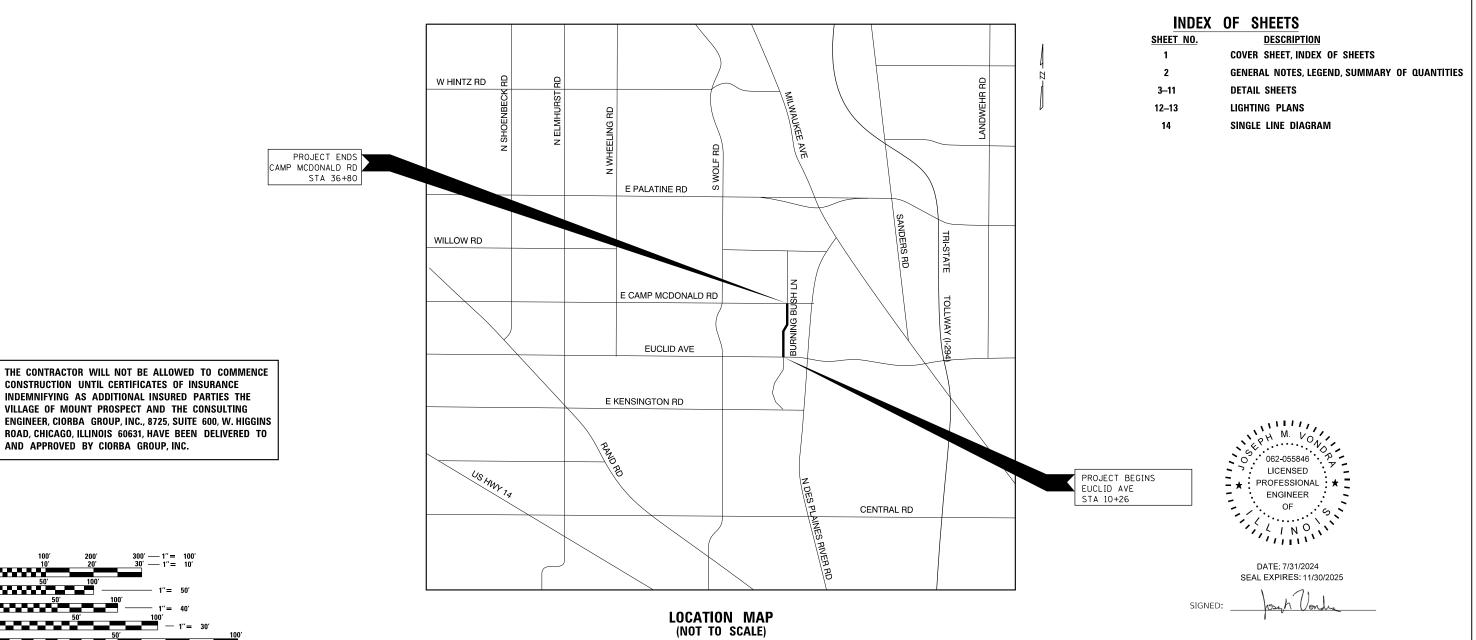

FULL SIZE PLANS HAVE BEEN PREPARED USING STANDARD ENGINEERING SCALES. REDUCED SIZED PLANS WILL NOT CONFORM TO STANDARD SCALES. IN MAKING MEASUREMENTS ON REDUCED PLANS, THE ABOVE SCALES MAY BE USED.

J.U.L.I.E.
JOINT UTILITY LOCATION INFORMATION FOR EXCAVATION
1-800-892-0123

OR 811

 \bigcirc

GROSS LENGTH = 2,694 FEET (0.51 MILES) NET LENGTH = 2,694 FEET (0.51 MILES)



DESIGN FIRM REGISTRATION NUMBER: 184-001016 8725 W. Higgins Road, Suite 600 | Chicago, IL 60631 P 773.775.4009 | www.ciorba.com

THE CONTRACTOR WILL BE REQUIRED TO MAINTAIN INGRESS AND EGRESS FOR EMERGENCY VEHICLES AT ALL TIMES DURING THE CONSTRUCTION PERIOD. DURING CONSTRUCTION, GARBAGE TRUCKS MUST BE PERMITTED ACCESS TO THE WORK ZONE IN ORDER TO PICK UP COMMERCIAL GARBAGE FOR THOSE PROPERTIES IMPACTED BY CONSTRUCTION. IF GARBAGE TRUCKS ACCESS IS NOT PROVIDED, THE CONTRACTOR WILL BE REQUIRED TO MOVE TRASH CONTAINERS TO AN ACCESSIBLE LOCATION.

UNDERGROUND UTILITIES

THE LOCATIONS OF THE UNDERGROUND UTILITIES AS SHOWN ON THE PLANS HAVE BEEN OBTAINED BY FIELD SURVEYS AND SEARCHES OF AVAILABLE RECORDS. IT IS BELIEVED THAT THE DATA IS ESSENTIALLY CORRECT, BUT THE VILLAGE OF MOUNT PROSPECT, AND/OR OTHER OFFICES AND AGENCIES ASSOCIATED WITH THE DEVELOPMENT OF THESE PLANS DO NOT GUARANTEE THEIR ACCURACY OR COMPLETENESS. THE CONTRACTOR WILL BE REQUIRED TO VERIFY THE LOCATION OF EACH FACILITY WITH THE UTILITY COMPANY, AND SHALL TAKE DUE CARE IN ALL PHASES OF THE CONSTRUCTION TO PROTECT ANY SUCH FACILITIES WHICH MAY BE AFFECTED BY THE WORK. ANY DAMAGE TO THE EXISTING UTILITIES SHALL BE REPAIRED IN ACCORDANCE WITH ARTICLE LR 105.

ADJUSTMENTS REQUIRED BY UTILITY COMPANIES WILL BE PERFORMED BY THE COMPANY INVOLVED OR ITS CONTRACTOR, BUT WILL BE COORDINATED BY THE GENERAL CONTRACTOR

COORDINATION OF ALL UTILITY WORK INVOLVED IN THE CONSTRUCTION AREA WILL BE DISCUSSED AT A PRE-CONSTRUCTION CONFERENCE.

THE CONTRACTOR SHALL USE EXTREME CAUTION IN THE REMOVAL OF ABANDONED EXISTING GAS LINES SINCE RESIDUAL MATERIALS CONTAINED THEREIN ARE HIGHLY EXPLOSIVE, FLAMMABLE, AND TOXIC. ONCE THE MAINS ARE ABANDONED BY THE OWNER, THE CONTRACTOR SHALL ASSUME ALL RESPONSIBILITY FOR ANY DAMAGE AND/OR INJURY OCCURRING ON THE PROJECT DUE TO HIS OPERATIONS NEXT TO THE MAINS AND/OR THE METHOD OF REMOVAL OF THE ABANDONED MAINS.

OPEN EXCAVATION

THE CONTRACTOR WILL NOT BE ALLOWED TO LEAVE EXCAVATIONS OPEN OVERNIGHT. THE CONTRACTOR WILL BE RESPONSIBLE FOR COMPLETELY BACKFILLING OR PLATING OVER ALL EXCAVATIONS AT THE END OF EACH DAY. IF THE EXCAVATIONS ARE BACKFILLED THEY SHALL BE FILLED WITH AN AGGREGATE MEETING THE GRADATION OF CA-6. THE MATERIAL WILL BE COMPACTED SUFFICIENTLY TO PREVENT RUTTING OR SETTLEMENT OF MATERIALS UNDER TRAFFIC LOADS. IF PLATES ARE USED THEY SHALL BE OF SUFFICIENT THICKNESS TO SUPPORT VEHICULAR LOADS. ADDITIONALLY THEY SHALL EXTEND A MINIMUM OF NINE INCHES (9") BEYOND THE LIMITS OF THE EXCAVATION ON ALL SIDES. IF THE PLATES ARE TO BE LEFT OVER THE WEEKEND, THE EDGES OF THE PLATES SHALL BE CUSHIONED WITH A BITUMINOUS MIXTURE IN AREAS WHERE VEHICULAR TRAFFIC WILL

THE COST FOR PROVIDING THE AGGREGATE, PLATES AND BITUMINOUS MIXTURE WILL NOT BE PAID FOR DIRECTLY BUT SHALL BE INCLUDED IN THE VARIOUS CONTRACT ITEMS.

TREE PROTECTION

THE CONTRACTOR SHALL BE RESPONSIBLE FOR BEING FAMILIAR WITH AND COMPLYING WITH ALL ASPECTS OF THE VILLAGE OF MOUNT PROSPECT TREE PROTECTION ORDINANCES AND ARBORICULTURAL STANDARDS MANUAL.

IF ANY STREET SIGNS ARE DAMAGED DURING CONSTRUCTION THEY SHALL BE REPLACED AT THE CONTRACTOR'S EXPENSE.

MAINTENANCE OF EXISTING DRAINAGE STRUCTURES

LOOSE MATERIAL THAT IS DEPOSITED IN THE FLOW LINE OF GUTTERS OR DRAINAGE STRUCTURES THAT INHIBITS THE NATURAL FLOW OF WATER SHALL BE REMOVED AT THE CLOSE OF EACH WORKING DAY, AT THE CONCLUSION OF THE CONSTRUCTION OPERATIONS, ALL DRAINAGE FACILITIES SHALL BE CLEAN AND FREE OF ALL OBSTRUCTIONS. THE COST OF THIS WORK SHALL BE INCLUDED IN THE VARIOUS CONTRACT ITEMS.

SAW CUTTING

THE CONTRACTOR SHALL SAW CUT ASPHALT PAVEMENT AND CONCRETE PAVEMENT AS INDICATED ON THE PLANS OR AS DIRECTED BY THE ENGINEER, TO SEPARATE THE EXISTING PAVEMENT TO BE REMOVED BY MEANS OF AN APPROVED CONCRETE SAW TO A DEPTH AS DIRECTED BY THE ENGINEER. SUITABLE GUIDELINES OR DEVICES SHALL BE USED TO ASSURE CUTTING A NEAT, STRAIGHT LINE AS SHOWN ON THE PLANS. CARE SHALL BE TAKEN BY THE CONTRACTOR SO AS NOT TO DAMAGE THE REMAINING PAVEMENT DIRECTLY ADJACENT TO THE PAVEMENT TO BE REMOVED. ANY DAMAGE TO THE EXISTING PAVEMENT RESULTING FROM PAVEMENT REMOVAL OPERATIONS SHALL BE REPAIRED AT THE CONTRACTOR'S EXPENSE. THE PRICE OF SAW CUTTING, AS NOTED ABOVE, SHALL BE INCLUDED IN THE PARTICULAR PAY ITEMS.

TRAFFIC PROTECTION

WHEN WORK COMMENCES, THE CONTRACTOR SHALL ASSUME THE MAINTENANCE OF ALL PAVEMENT, SHOULDERS, DRAINAGE FACILITIES, TRAFFIC CONTROL SIGNS, PAVEMENT MARKING, AND OTHER APPURTENANCES ON ROADWAYS WITHIN THE LIMITS OF THE CONTRACT WHICH ARE TO BE USED BY THE PUBLIC DURING CONSTRUCTION AND TO RETAIN THIS MAINTENANCE RESPONSIBILITY UNTIL PROJECT COMPLETION. NEED FOR SNOW AND ICE CONTROL DURING THE CONSTRUCTION PERIOD SHALL BE ACCOMMODATED FOR BY OTHERS. ALL UNBALLASTED TYPE I & II BARRICADES SHALL HAVE TWO SANDBAGS ONE ACROSS EACH BOTTOM RAIL.

SUMARY OF QUANTITIES

	PAY ITEM NO.	DESCRIPTION	UNIT	QUANTITY
	1	UNDERGROUND CONDUIT, GALVANIZED STEEL, 2"	FOOT	20
	2	UNDERGROUND CONDUIT, GALVANIZED STEEL, 3"	FOOT	319
	3	UNIT DUCT, 600V, 2-1C NO.6, 1/C NO.8 GROUND, (XLP-TYPE USE), 1" DIA. POLYETHYLEN	I FOOT	2,666
	4	ELECTRIC CABLE IN CONDUIT, 600V (XLP-TYPE USE), 1/C NO. 2	FOOT	210
	5	LIGHT STANDARD, ALUMINUM, 25' M.H., 10 FT. CLAMP-ON MAST ARM, LED LUMINAIRE	EACH	9
*	6	LIGHT STANDARD, ALUMINUM, 25' M.H., 12 FT. CLAMP-ON MAST ARM, LED LUMINAIRE	EACH	1
*	7	LIGHT STANDARD, ALUMINUM, 25' M.H., 15 FT. CLAMP-ON MAST ARM, LED LUMINAIRE	EACH	1
	8	ELECTRIC UTILITY SERVICE CONNECTION (COMED)	L SUM	1
	9	9 ELECTRIC SERVICE INSTALLATION		1
	10	LIGHTING CONTROLLER	EACH	1
	11	BREAKAWAY DEVICE WITH ALUMINUM SKIRT	EACH	11
	12	LIGHT POLE FOUNDATION, METAL, 11" BOLT CIRCLE, 8 5/8" X 6'	EACH	11
*	13	TREE PROTECTION FENCE	FOOT	500
*	14	COMBINATION CONCRETE CURB AND GUTTER REMOVAL AND REPLACEMENT	FOOT	10
	15	TRAFFIC CONTROL AND PROTECTION		1
	16	ELECTRICAL HANDHOLE		1
*	17	CLASS D PATCHES, SPECIAL	SQ YD	5
	18	MAINTENANCE BOND (24-MONTH)	L SUM	1

^{* =} NOMINAL QUANTITY PROVIDED FOR ADJUSTMENTS DURING CONSTRUCTION

LEGEND

O—O EXISTING LIGHT POLE AND LUMINAIRE

→ EXISTING MAST ARM AND LUMINAIRE MOUNTED ON UTILITY POLE

 $ightharpoonup {\mathsf{R}}$ Existing mast arm and luminaire to be removed

LIGHT STANDARD, 25 FT. M.H., 10 FT. CLAMP-ON MAST ARM, LED LUMINAIRE ON LIGHT POLE FOUDATION, METAL

PROPOSED HANDHOLE

PROPOSED LIGHTING CONTROLLER ▶⋖

> PROPOSED UNIT DUCT WITH 2-1/C No. 6 & 1-1/C No. 8 GROUND, 600V (XLP-TYPE USE), 1" DIA. OR AS NOTED


PROPOSED RIGID GALVANIZED STEEL CONDUIT

 CONTROLLER IDENTIFICATION (TYP.) CIRCUIT NUMBER (TYP.)

ÁÍ-1→— POLE NUMBER (TYP.)



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PLOT DATE = 7/31/2024	DATE	-	5/24/2024	REVISED	-

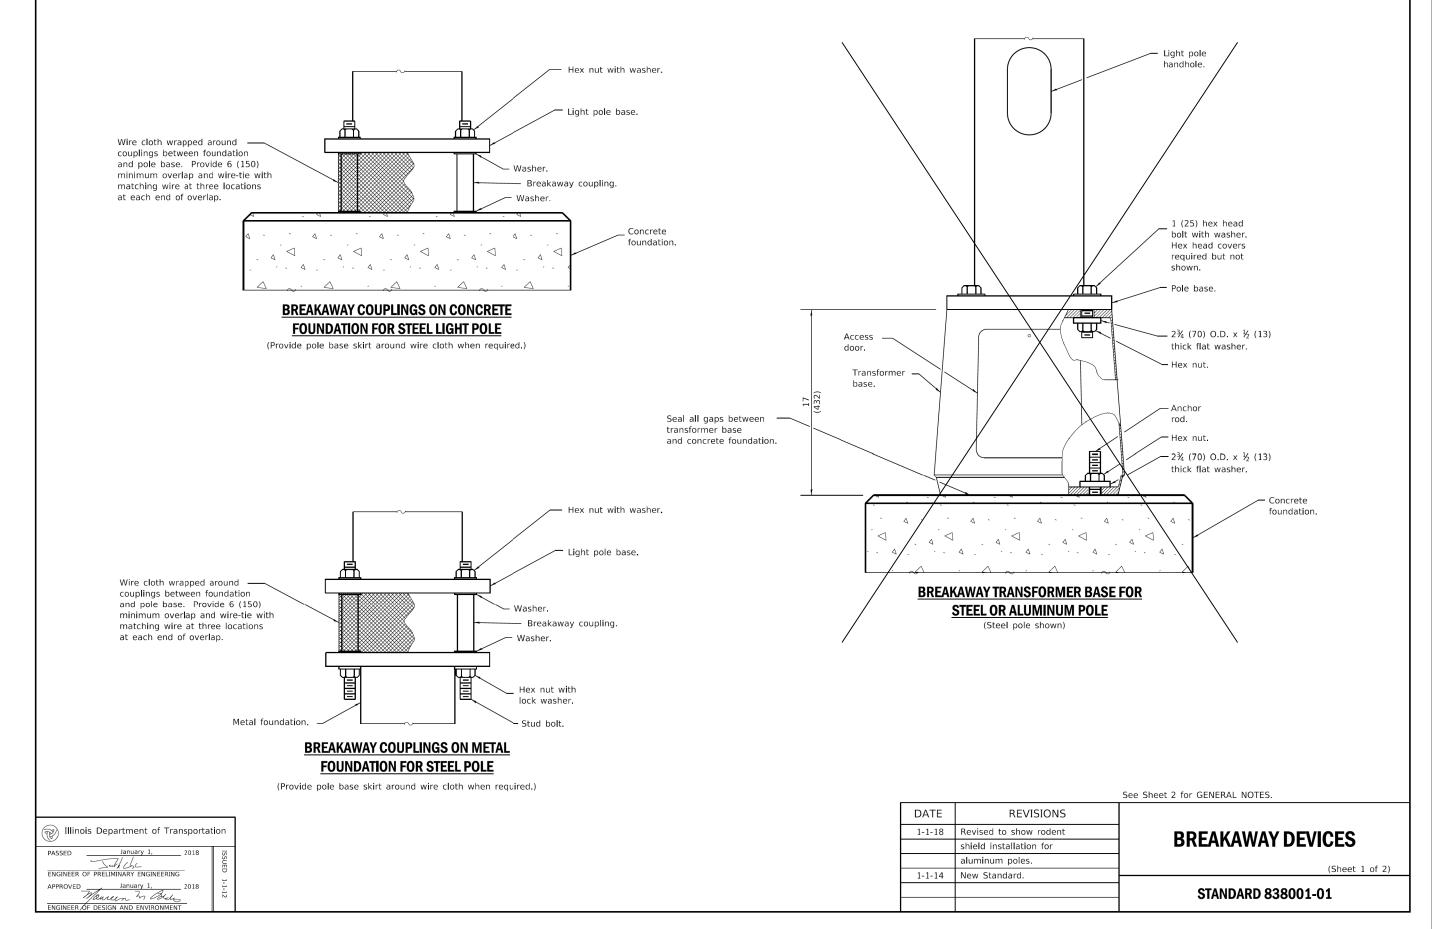

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BURNING BUSH LANE STREET LIGHTING VILLAGE OF MOUNT PROSPECT, ILLINOIS


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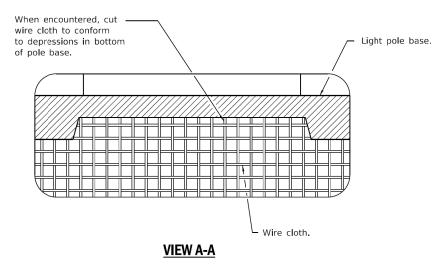
LIGHTING DETAILS


RTE. SECTION COUNTY TOTAL SHEET NO.

COOK 14 3

SHEET NO. 1 OF 9 SHEETS STA. TO STA. | ILLINOIS FED. AID PROJECT



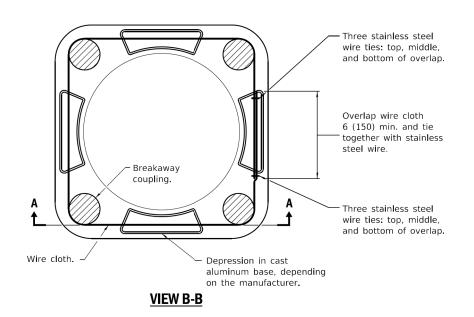

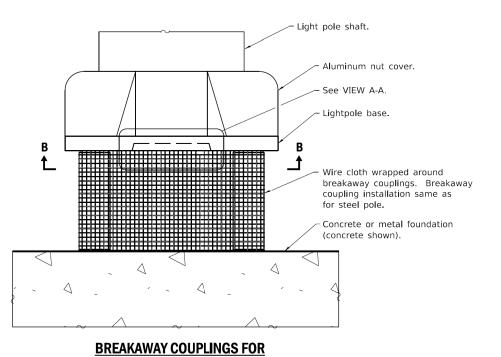

ALUMINUM POLES

(Provide pole base skirt around wire cloth when required.)

GENERAL NOTES

See light pole standard for details not shown.

Use largest transformer base bolt circle possible.

Transformer bases shall not be installed on metal foundations.

Washers on top of pole base shall cover the entire bolt slot.

See Standard 836001 for Light Pole Foundation.

Wire cloth shall be stainless steel, have a maximum opening of $\frac{1}{4}$ (6), and have a minimum wire size of AWG No. 16 (1.6).

All dimensions are in inches (millimeters) unless otherwise shown.

BREAKAWAY DEVICES

(Sheet 2 of 2)

STANDARD 838001-01

Illinois Department of Transportat	ion
PASSED January 1, 2018 ENGINEER OF PRELIMINARY ENGINEERING	ISSUED
APPROVED January 1, 2018 Manuer & Bulk ENGINEER OF DESIGN AND ENVIRONMENT	1-1-12


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PLOT DATE = 7/31/2024	DATE	-	5/24/2024	REVISED -	

BURNING BUSH LANE STREET LIGHTING **VILLAGE OF MOUNT PROSPECT, ILLINOIS**

				RTE.	SECTION	COUNTY	TOTAL SHEETS	SHEET NO.
	LIGHTING DETAILS					COOK	14	4
SCALE: N.T.S.	SHEET NO. 2 OF 9 SHEETS	STA.	TO STA.		ILLINOIS FED. A	ID PROJECT		

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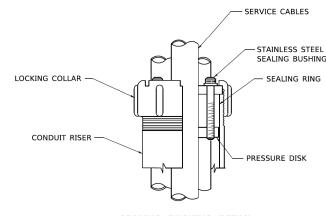


APPLICATION

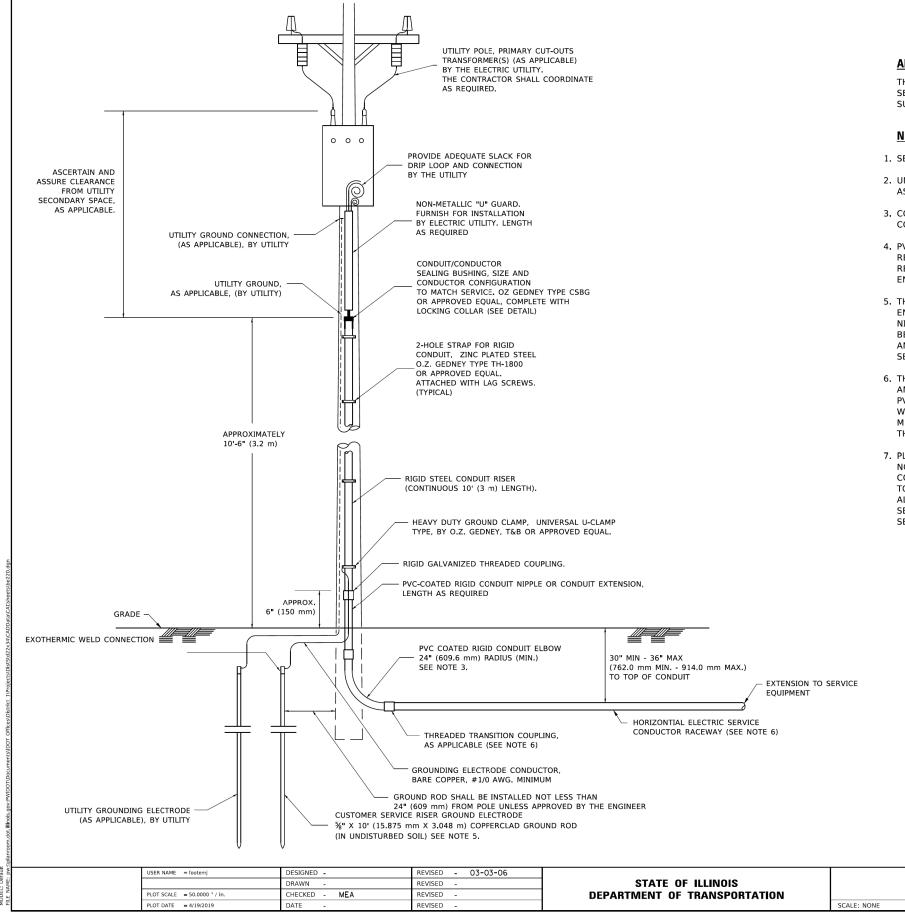THIS DETAIL APPLIES FOR LOW VOLTAGE ELECTRIC SERVICE (600 V OR LESS) FROM AN OVERHEAD UTILITY SUPPLY TO SEPERATLY-MOUNTED SERVICE EQUIPMENT.

NOTES

- 1. SERVICE VOLTAGE SHALL BE AS INDICATED ELSEWHERE IN THE DRAWINGS.
- 2. UNLESS OTHERWISE INDICATED, ITEMS AND WORK SHALL BE INCLUDED AND PAID AS PART OF THE ELECTRIC UTILITY SERVICE INSTALLATION PAY ITEM.
- 3. CONDUIT AND CONNECTOR DIAMETER SHALL MATCH THE DIAMETER OF THE SERVICE CONDUCTOR RACEWAY AS INDICATED ON THE PLANS.
- 4. PVC COATED RACEWAYS AND ACCESSORIES SHALL BE CAREFULLY INSTALLED WITH MFR RECOMMENDED TOOLS AND PROCEDURES TO AVOID DAMAGE. ANY DAMAGE SHALL BE REPAIRED WITH COMPATIBLE PVC TOUCH-UP MATERIAL TO THE SATISFACTION OF THE ENGINEER OR THE DAMAGED MATERIAL SHALL BE REPLACED AT NO ADDITIONAL COST.
- 5. THE CONTRACTOR SHALL OBTAIN INSPECTION AND APPROVAL BY THE ENGINEER OF SERVICE RISER GROUND ELECTRODE, RISER ELBOW, NIPPLE AND CONNECTION TO SERVICE CONDUCTOR RACEWAY EXTENSION BEFORE BACKFILL AND SHALL ALSO OBTAIN INSPECTION OF SERVICE RISER AND SEALING BUSHING BEFORE UTILITY "U" GUARD INSTALLATION AND SERVICE CONNECTION.
- 6. THE HORIZONTAL ELECTRIC SERVICE CONDUCTOR RACEWAY SHALL BE AS INDICATED AND SHALL BE MEASURED SEPARATELY FOR PAYMENT. WHEN THE RACEWAY IS PVC-COATED RIGID GALVANIZED STEEL, THE COUPLING SHALL BE THE SAME. WHEN THE RACEWAY IS PVC CONDUIT (IN CONCRETE), THE COUPLING SHALL BE A METALIC TO NON METALIC ADAPTER. WHEN THE RACEWAY IS ENCASED IN CONCRETE, THE CONCRETE SHALL EXTEND TO COVER THE COUPLING.
- 7. PLANS AND DETAILS INDICATE THE GENERAL NATURE AND REQUIREMENTS. THEY DO NOT SHOW EVERY ACCESSORY AND ATTACHMENT, AND THEY DO NOT RELIEVE THE CONTRACTOR OF THE REQUIREMENTS OF THE SPECIFICATIONS AND SPECIAL PROVISIONS TO ASCERTAIN UTILITY REQUIREMENTS AND TO COORDINATE ACCORDINGLY, FURNISHING ALL ITEMS AND WORK NOT PROVIDED BY THE UTILITY, BUT NECESSARY FOR A COMPLETE SERVICE INSTALLATION IS REQUIRED AND SHALL BE INCLUDED IN THE ELECTRIC UTILITY SERVICE INSTALLATION PAY ITEM.



SEALING BUSHING DETAIL

: Defa	d Silver	USER NAME = Tootemj	DRAWN -	REVISED - U3-U3-U6	STATE OF ILLINOIS		ELECTRIC SERVICE INSTALLATION			SECTION	COUNTY SHEETS NO.	4
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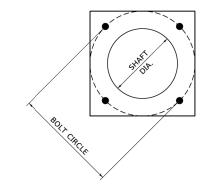
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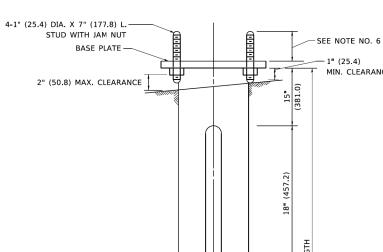
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	LIGHTING DETAILS			RTE.	SECTION	COUNTY	TOTAL SHEETS	SHEET NO.
						COOK	14	5
SCALE: N.T.S.	SHEET NO. 3 OF 9 SHEETS	STA.	TO STA.		ILLINOIS FED. A	D PROJECT		





2½" (63.5)

SHAFT DIA.

HELIX FOUNDATION SIZE

POLE MOUNTING HEIGHT	BOLT CIRCLE	SHAFT DIAMETER	SHAFT LENGTH	BASEPLATE
30 FT.	11½"	8%"	6 FT.	12"x12"x1"
31 FT35 FT.	11½"	8%"	6 FT.	12 " x12"x1"
36 FT40FT.	15"	8%"	6 FT.	15"x15"x1¼"
41 FT45 FT.	15"	8%"	6 FT.	15"x15"x1¼"
46 FT50 FT.	15"	10"	8 FT.	15"x15"x1¼"

METAL HELIX FOUNDATION MATERIALS

ITEM	MATERIAL REQUIREMENT
BASEPLATE	AASHTO M 270M, GRADE 36 (M270M, GRADE 250)
SHAFT	ASTM A 252, GRADE 2 (PHOSPHOROUS 0.04% MAXIMUM, SULFUR 0.05% MAXIMUM)
HELIX SCREW	AASHTO M 183 (ASTM A 635)
PILOT POINT	AASHTO M 270 (ASTM A 575)
ANCHOR RODS/STUDS	AASHTO M 314 (ASTM F 1554)
HEXAGON NUTS	AASHTO M 291M (ASTM A 563) GRADE DH, OR AASHTO M 292 (ASTM A 194) GRADE 2H
WASHERS	AASHTO M 293 (ASTM F 436)

NOTES

- 1. ALL DIMENSION IN INCHES (MILLIMETERS) UNLESS OTHERWISE SHOWN.
- 2. ALL MATERIAL SHALL BE GALVINIZED ACCORDING TO AASHTO M111, UNLESS OTHERWISE SPECIFIED.
- 3. ALL WELDS SHALL BE CONTINUOUS AND NOT LESS THAN 1#4" (6.35 mm) FILLET WELDS. THE WELDED FOUNDATION SHALL BE CAPABLE OF WITHSTANDING 10,000 FT/LBS (13558.18 n.m) OF INSTALLATION TORQUE APPLIED ABOUT THE AXIS OF THE FOUNDATION.
- 4. THE HELIX FOUNDATION SHAFT SHALL BE INSTALLED VERTICAL AND THE BASE PLATE SHALL BE IN LEVEL. THE BREAKAWAY COUPLINGS AND HARDWARE SHALL NOT BE USED TO ALIGN THE
- 5. THE CABLE TRENCH SHALL BE BACKFILLED AND FIRMLY COMPACTED BEFORE THE INSTALLATION OF THE LIGHT POLE.
- 6. THE CONTRACTOR SHALL COORDINATE EXTENSION OF ANCHOR BOLTS ABOVE TOP OF THE BASE PLATE WITH THE BREAKAWAY DEVICE MANUFACTURER'S REQUIREMENTS.
- 7. ANY VOIDS WITHIN THE METAL FOUNDATION SHALL BE FILLED WITH FINE AGGREGATE.
- 8. METAL FOUNDATIONS SHALL BE INSTALLED IN UNDISTURBED SOIL, PREDRILLING A PILOT HOLE AND/OR BACKFILLING AROUND THE FOUNDTION IS NOT ALLOWED.
- 9. THE METAL FOUNDATION SHALL NOT BE INSTALLED TO A TORQUE WHICH EXCEEDS THE MANUFACTURER'S MAXIMUM TORQUE RATING NOR SHALL IT BE INSTALLED TO AN INSTALLATION TORQUE VALUE OF LESS THAN 3,500 FT LB (4,750 KNM). METAL FOUNDATIONS THAT ARE NOT INSTALLED TO FULL INSTALLATION DEPTH OR DO NOT ACHIEVE THE MINIMUM INSTALLATION TORQUE SHALL BE REMOVED AND REPLACED WITH A CONCRETE FOUNDATION AT NO ADDITIONAL COST.
- 10. THE BASEPLATE SHALL BE PERPENDICULAR TO THE SHAFT AXIS (\pm 1 $^{\circ}$) AND THE HOLE CENTERLINE SHALL BE CONCENTRIC (± 0.188) TO THE SHAFT AXIS.
- 11. THE PILOT POINT AND SHAFT AXIS SHALL BE CONCENTRIC (± 0.125) AND IN LINE (\pm 2 $^{\circ}$).
- 12. THE BASEPLATE SHALL BE STAMPED WITH THE MANUFACTURERS NAME AND DATE OF MANUFACTURE.

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STATE OF ILLINOIS **DEPARTMENT OF TRANSPORTATION**

1¼" (31.75) DIA.

MIN. CLEARANCE


0.25" WALL, MIN.

								RTE.	SEC	TION		COUNTY	SHEETS	
LIGHT POLE FOUNDATION, METAL														
									BE-30	15		CONTRACT	NO.	
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	RTE.	SECTION	COUNTY	TOTAL SHEETS	SHEET NO.
LIGHTING DETAILS			COOK	14	6
SCALE: N.T.S. SHEET NO. 4 OF 9 SHEETS STA. TO STA.		ILLINOIS FED. AI	D PROJECT		



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DESIGNED - AM REVISED USER NAME = untitled DRAWN - DTJ REVISED PLOT SCALE = 3.3333 ' / in. CHECKED - JMV REVISED PLOT DATE = 7/31/2024 - 5/24/2024 REVISED DATE

BURNING BUSH LANE STREET LIGHTING **VILLAGE OF MOUNT PROSPECT, ILLINOIS**

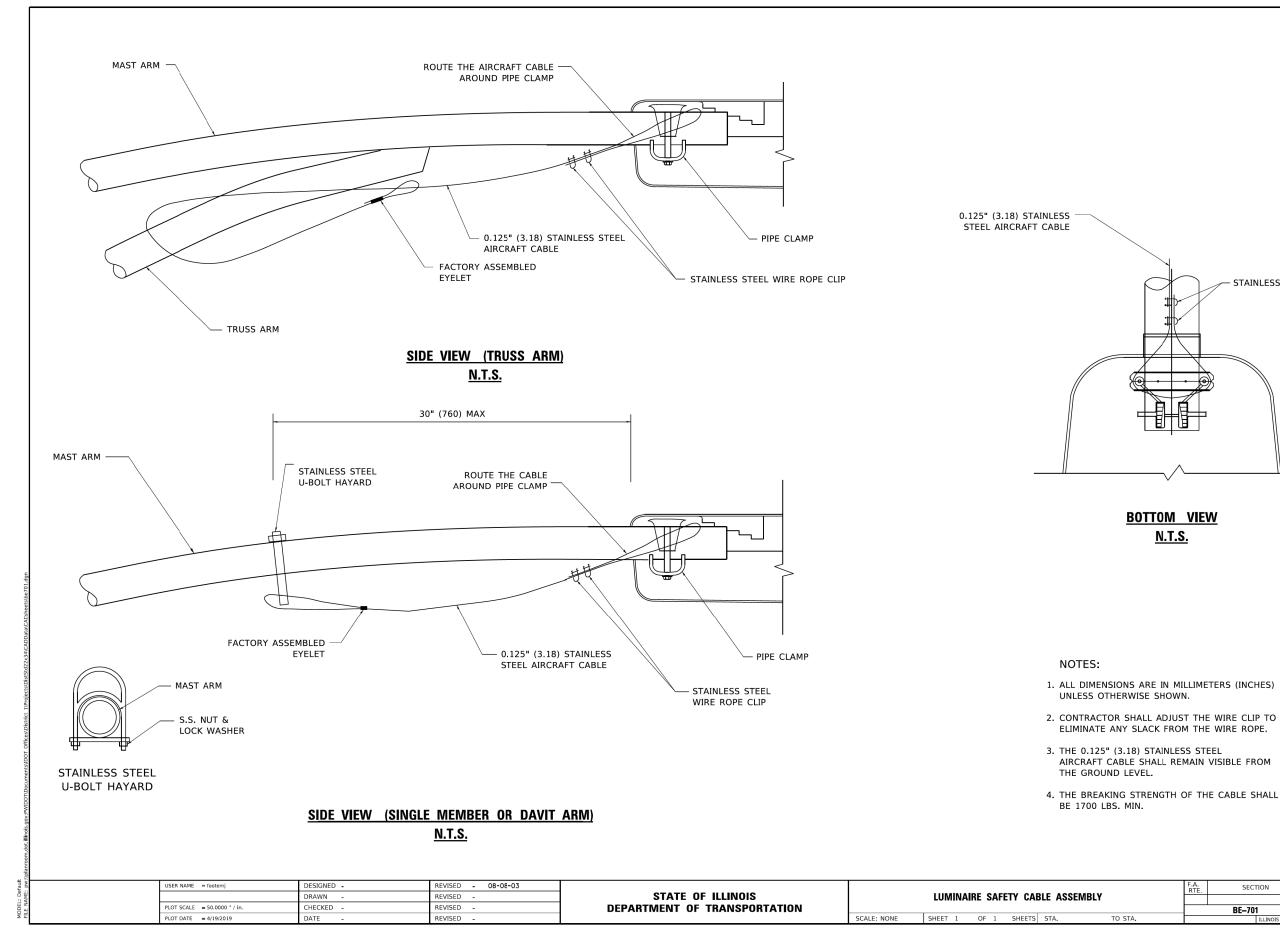SECTION COUNTY LIGHTING DETAILS COOK SCALE: N.T.S. SHEET NO. 5 OF 9 SHEETS STA. TO STA. ILLINOIS FED. AID PROJECT

SECTION


BE-701

COUNTY

CONTRACT NO

STAINLESS STEEL WIRE ROPE CLIP

LIGHTING CONTROLLER & FOUNDATION

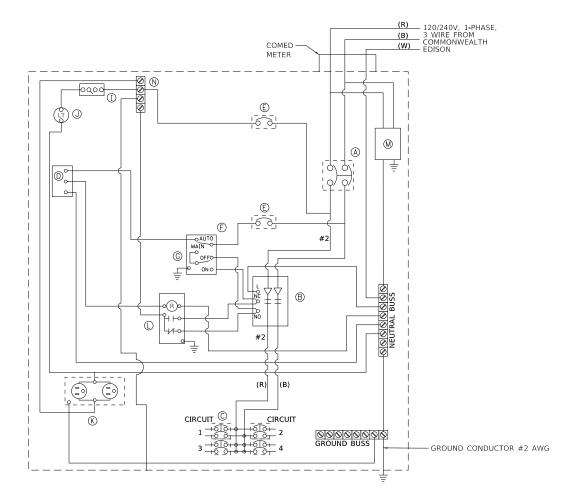

	DEVICE SCHEDULE							
QUANTITY	DESCRIPTION							
1	100 AMP CIRCUIT BREAKER, MOLDED CASE, THERMAL MAGNETIC, 2-POLE, SINGLE THROW, 600V FRAME, NON-INTERCHANGABLE TRIP, BOLT ON TYPE.							
1	100 AMP, ELECTRICALLY OPERATED AND MECHANICALLY HELD LIGHTING CONTRACTOR, 2-POLE, 600 VOLT WITH 120 V COIL							
4	4 120/240 VOLT 1 PHASE PANEL BOARD WITH 100 AMP COPPER MAINS TWO POLE, 30 AMP, 120 VOLT BOLT ON BRANCH CIRCUIT BREAKERS							
1	TERMINAL BLOCK FOR REMOTE PHOTOCELL							
E 2 THERMAL MAGNETIC, MOLDED CASE CIRCUIT BREAKER, 1 POLE, 15 AMP, 120 VOLT BOLT ON								
1	CONTROL SWITCH, MOMENTARY CONTACT, SPDT, 15 AMP, 120 VOLT							
1	CONTROL SWITCH, TOGGLE TYPE, SPDT, 20 AMP, 120 VOLT SPECIAL GRADE							
1	MICRO SWITCH (MOUNTED WITH ACTUATOR TO SWITCH WHEN DOOR IS OPEN) 120 VOLT, 20 AMP							
1	LED LIGHT FIXTURE VAPOR TIGHT WITH GLOBE, GUARD, AND MCUNTING BOX							
1	120 VOLT, 20 AMP RECEPTACLE, SPECIFICATION GRADE IN NEMA 5-15R WEATHER PROOF BOX WITH FLAP-TYPE COVER. OUTLET TO BE GFI-TYPE.							
1	POWER RELAY WITH 25 AMP CONTACTS RATED FOR CONTRACTOR INRUSH CURRENT - 120 VOLT COIL							
1	SURGE ARRESTOR, 5 WIRE EDCO "4803 OR EQUAL							
1	TERMINAL BLOCK, 120 VOLT, 50 AMP MAXIMUM WITH NUMBER OF TERMINALS AS INDICATED							
	1 1 2 1 1 1 1 1 1 1 1 1							

- NOTES:


 1. ALL CIRCUIT BREAKERS SHALL HAVE AN INTERRUPT RATING OF 18,000 AMPS
 2. UL LISTED DEVICES/COMPONENTS SHALL BE USED
 3. NO SPLICES OF WIRES IN CABINET
 4. CONTROL WIRE TO BE #12 MTW
 5. POWER WIRE SHALL BE RATED RHH/RHW 600 VOLTS OF SIZE INDICATED
 6. LIGHTING CONTROLLER SHALL BE SERVICE ENTRANCE RATED
 7. PANEL SHALL BE DEAD FRONT TO ALLOW OPERATION OF HOA SWITCH

120/240 VOLT CONTROLLER PANEL WIRING DIAGRAM



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PLOT DATE = 7/31/2024	DATE - 5/24/2024	REVISED -


LIQUITING DETAILS							SECTION	COUNTY	TOTAL SHEETS	SHEET NO.
LIGHTING DETAILS								COOK	14	8
						1				
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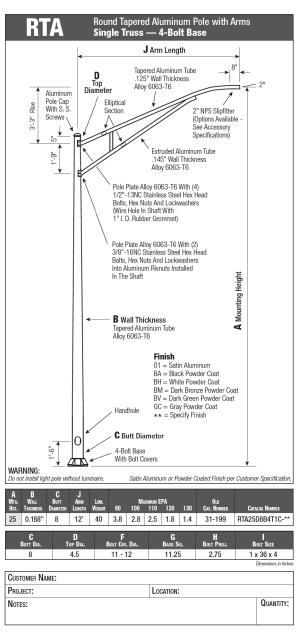


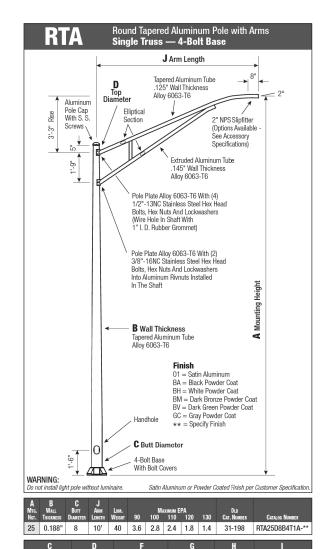
4.5 11 - 12 11.25 2.75 1 x 36 x 4

QUANTITY:


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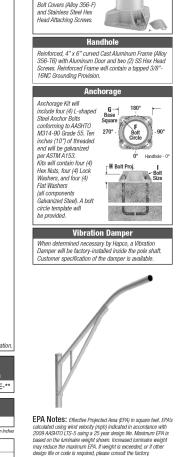
SCALE: N.T.S.

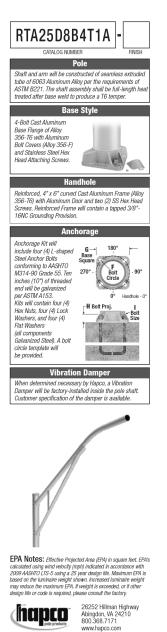

LOCATION:

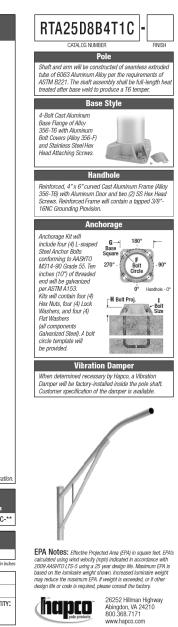PROJECT:

Notes:

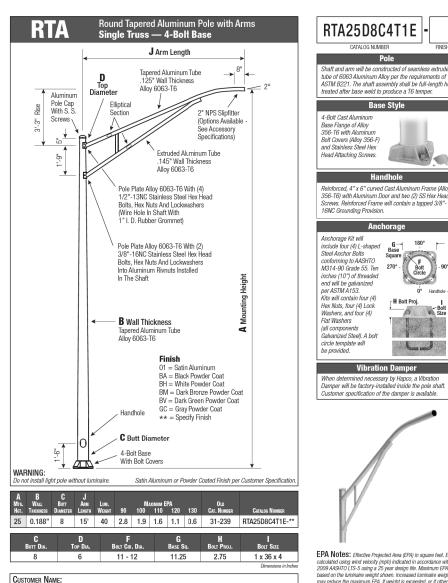

26252 Hillman Highway

Abingdon, VA 24210 800.368.7171

RTA25D8C4T1E

4-Bolt Cast Aluminum

Base Flange of Alloy

Shaft and arm will be constructed of seamless extrude

ASTM B221. The shaft assembly shall be full-length heat treated after base weld to produce a T6 temper.

12' ARM 15' ARM 10' ARM



P 773 775 4009 L www.cjorba.com

CUSTOMER NAME:

PROJECT:

Notes:

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BURNING BUSH LANE STREET LIGHTING **VILLAGE OF MOUNT PROSPECT, ILLINOIS**

				RTE.	SECTION	COUNTY	TOTAL SHEETS	SHEET NO.
LIG	HTING DET	AILS				COOK	14	9
SHEET NO. 7 OF	9 SHEETS	STA.	TO STA.		ILLINOIS FED. AI	D PROJECT		

QUANTITY

Project


Catalog No.


ComfortView™

Neighborhood LED Streetlight (CV)

Luminaire Data

Weight 8lbs [3.6kg] **EPA** 0.39 ft²

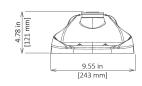

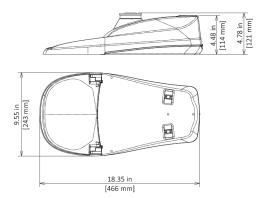

Ordering Information

Sample Catalog No. CV1-H-MV-40K-2R-GY-045-FOC

Product	LED Code	Voltage	Color Temperature	Distribution	Finish ¹	Output Code ²		Options
CV1	Н	MV 120-277V HV 347-480V	22K 2200K 27K 2700K	2R Type 2 3R Type 3	GY Gray DB Dark	025 030	FOC ³ LPCR	Fixed Output Code Less Photocontrol
			30K 3000K 40K 4000K		Bronze BK Black	035 040	PCR7 ⁴	Receptacle ANSI 7-wire Photo-
					Mid	block 050	PCR7-CR ⁵	control Receptacle Control Ready 7-wire PC Receptacle
					Interse	060	WL 4B	Utility Wattage Label 4-Bolt Mounting Bracket
						075 080	RWG SWTB	Rubber Wildlife Guard Straight Wire Terminal
							BBL	Block Bubble Level
							CF ⁶	Coastal Paint Finish

Notes:

- 1 Gray, Black, and Dark Bronze standard. Consult factory for other finishes.
- 2 Specified output code is the factory set lumen performance. Field adjustable is standard via an eight-position output selector. Refer to output data table on this spec sheet. An illustration of the output selector and its label is shown on page 2. Consult factory if special output setting is required.
- 3 Non-field adjustable, fixed lumen output. Specify required output code. Not available with PCR7-CR option.
- 4 Includes output selector that enables field adjustability of light levels. Includes connectors to allow easy upgrade of wireless dimming via PCR7. Wireless node by others.
- 5 Control-ready wired at factory for wireless node dimming (node by others). Output selector not included in the fixture. Not able to adjust above specified drive current.
- 6 Specify the CF Option for coastal installation. See warranty for details.
- 7 Flush mounted Cul-de-Sac Shield cuts light off at 1 times the mounting height behind the luminaire, 1% in front, and 2% times the mounting height laterally.
- 8 Flush mounted Front Side Shield cuts light off at approximately 1% times the mounting height in front of the luminaire (street side) and 2% times the mounting height laterally.
- 9 Flush mounted House Side Shield cuts light off at 1 times the mounting height behind the luminaire and 2% times the mounting height laterally.
- 10 80 Degree Cutoff Shield mitigates high angle glare above 80 degrees from nadir and cuts light off at $1\frac{1}{2}$ times the mounting height behind and $2\frac{1}{3}$ times the mounting height laterally.
- 11 Specify Color (GY, DB, BK)
- 12 Specify MV (120-277V) or HV (347-480V).

	Accessories
CSSCV ⁷	Cul-De-Sac Side Shield, Snap-On*
FSSCV ⁸	Front Side Shield, Snap-On*
HSSCV ⁹	House Side Shield, Snap-On*
VHCS ¹⁰	80 Degree Cutoff Shield, Grey*
PTB ¹¹	Pole Top Tenon Horizontal Arm Bracket
PTB2 ¹¹	Pole Top Tenon Horizontal Arm Bracket (2@180°)
RPB ¹¹	Round Pole Horizontal Arm Bracket
SPB ¹¹	Square Pole Horizontal Arm Bracket
WB^{11}	Wall Horizontal Arm Bracket
LLPC12	Long-Life Twist Lock Photocontrol
SC	Twist Lock Shorting Cap
BSK	Bird Deterrent Spider Kit

*Accessories are ordered separately and not to be included in the catalog number. For factory installed HSSCV, CSSCV, FSSCV and VHCS specify as option in luminaire catalog number. HSSCV, CSSCV, FSSCV can be installed without a tool, but a tool is required for removal. 80 Degree Cutoff Shield (VHCS) requires a Phillips head screwdriver for installation.









ComfortView™ Neighborhood LED Streetlight (CV)

Performance Data¹

All data nominal. IES files for all CCTs available at leotek.com.

Product	Color Temperature (CCT)	Output Code	Dial Selection	System Wattage (W)	Delivered Lumens (Lm) ²	Efficacy (Lm/W)	Field Adjustable Output Range
		020	1	19	2087	110	1
		025	2	24	2693	112	
		030	3	29	3224	111	
	2200 (221)	040	4	34	3876	114	
	2200 (22K)	043	5	38	4222	111	
		045	6	43	4653	108	
		050	7	48	5101	106	
		065	8	66	6722	102	1 ↓
		025	1	19	2242	118	1
		030	2	24	2892	120	Midblock Intersection
		035	3	29	3463	119	
	27001/ (271/)	040	4	34	4163	122	Midblock
	2700K (27K)	045	5	38	4535	119	
		050	6	43	4998	116	
		055	7	48	5479	114	
CV1-H		070	8	66	7220	110	Intersection
[CV1-11]		025	1	19	2412	127	
		030	2	24	3073	128	
		035	3	29	3676	127	
	3000K (30K)	045	4	35	4423	128	
	3000K (30K)	050	5	38	4777	126	
		055	6	45	5561	124	
		060	7	49	5800	118	
		075	8	67	7722	115	<u> </u>
		025	1	19	2675	139	<u> </u>
		035	2	24	3294	137	
		040	3	29	3930	136	
	4000K (40K)	045	4	34	4561	134	
	40000 (400)	050	5	38	5059	133	
		055	6	43	5594	130	
		060	7	48	6147	128	
		080	8	67	8227	123	\ \

Notes:


- 1 Data shown above is for type 2 optic. For type 3 optic, consult IES files for specific data at Leotek.com
- $2\ \ \text{Nominal lumens. Normal tolerance} \pm 10\% \ \text{due to factors including LED bin variance, and ambient temperatures.}$

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PLOT DATE = 7/31/2024	DATE	-	5/24/2024	REVISED	-

					RTE.	SECTION	COUNTY	TOTAL SHEETS	SHEET NO.
	LIG	HTING DET	AILS				COOK	14	10
SCALE: N.T.S.	SHEET NO. 8 OF	9 SHEETS	STA.	TO STA.	ILLINOIS FED. AID PROJECT				



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		RTE.	SECTION	COUNTY	SHEETS	NO.		
	LIGHTING DET	AILS				COOK	14	11
SCALE: N.T.S.	SHEET NO. 9 OF 9 SHEETS	STA.	TO STA.	ILLINOIS FED. AID PROJECT				

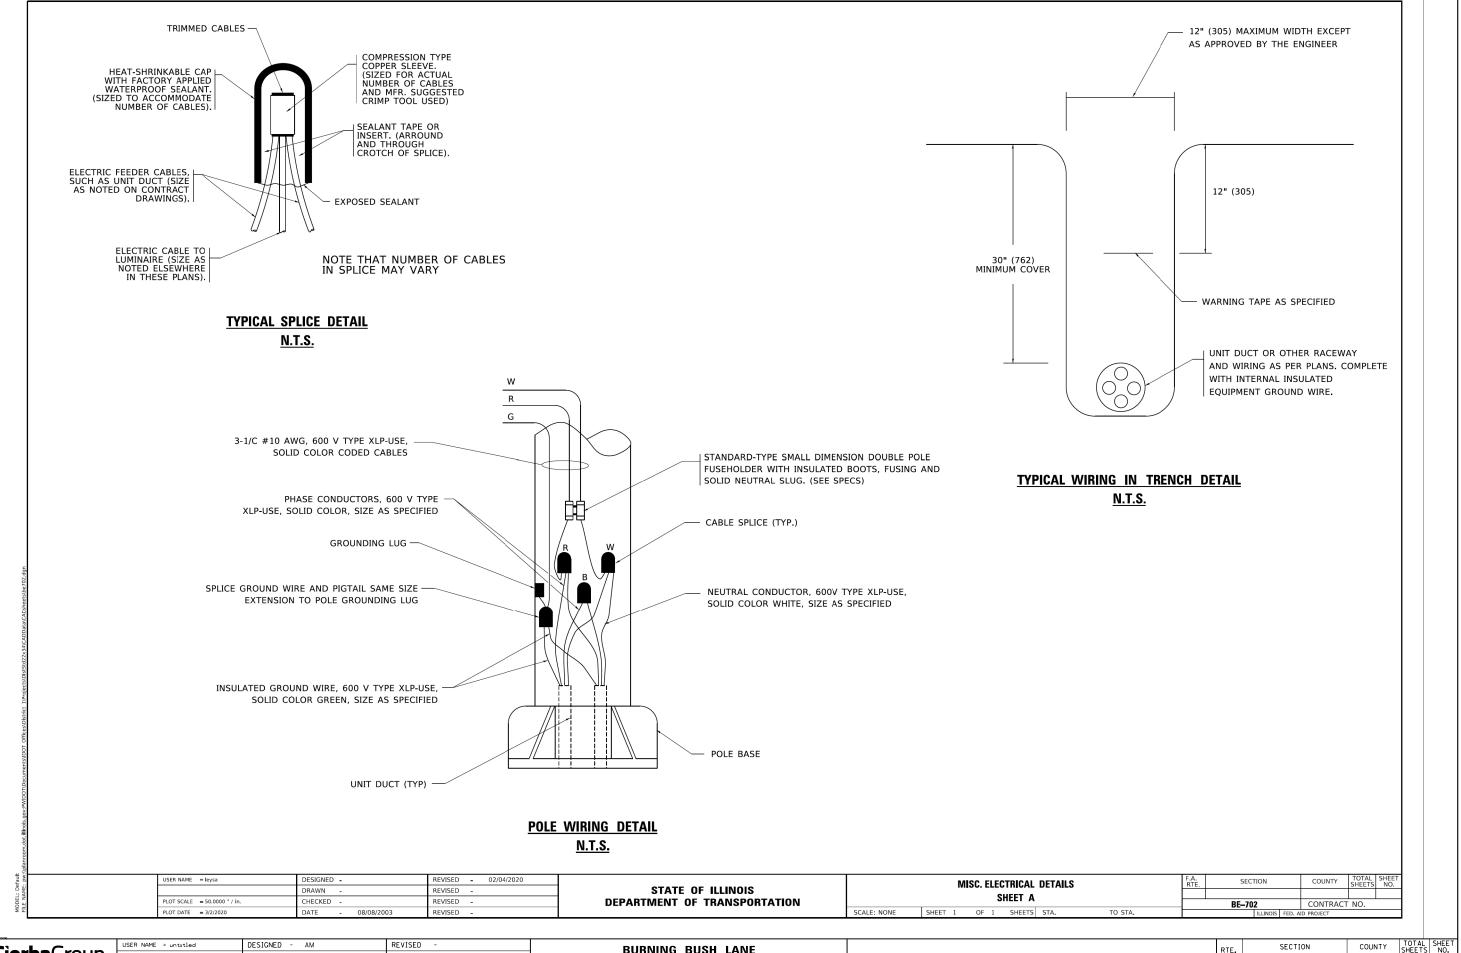LEGEND

O—O EXISTING LIGHT POLE AND LUMINAIRE

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LIGHT STANDARD, 25 FT. M.H., 10 FT. CLAMP-ON MAST ARM, LED LUMINAIRE ON LIGHT POLE FOUDATION, METAL

PROPOSED HANDHOLE

ightharpoonsPROPOSED LIGHTING CONTROLLER

PROPOSED UNIT DUCT WITH 2-1/C No. 6 & 1-1/C No. 8 GROUND, 600V (XLP-TYPE USE), 1" DIA. OR AS NOTED

PROPOSED RIGID GALVANIZED STEEL CONDUIT


— CONTROLLER IDENTIFICATION (TYP.) - CIRCUIT NUMBER (TYP.)


Á1-1- POLE NUMBER (TYP.)

NOTES


- 1. VILLAGE TO RELOCATE EXISTING STREET SIGNS FROM SIGN POSTS TO PROPOSED LIGHT POLES.
- 2. OFFSET LIGHTING UNITS NEAR DRIVEWAYS TO MAINTAIN 6 FEET FROM EDGE OF DRIVEWAY TO EDGE OF FOUNDATION UNLESS NOTED OTHERWISE.
- 3. LIGHTING UNIT SETBACK SHALL BE 3 FEET FROM FACE OF CURB TO CENTER OF FOUNDATION UNLESS NOTED OTHERWISE.
- 4. LUMINAIRES AT MID-BLOCK LOCATIONS SHALL HAVE OUTPUT CODE 050 AND LUMINAIRES AT INTERSECTIONS SHALL HAVE OUTPUT CODE 070.
- 5. WATERMAIN LOCATION SHALL BE VERIFIED IN THE FIELD PRIOR TO CONSTRUCTION.



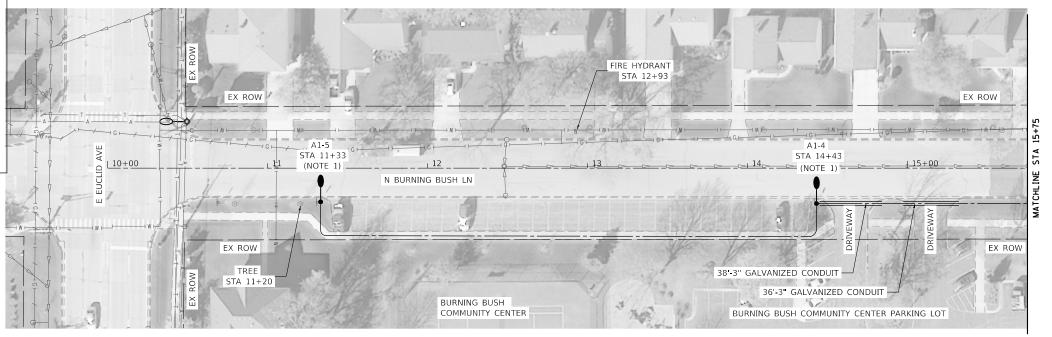

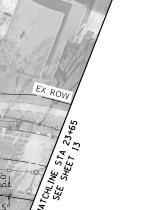

GRAPHIC SCALE

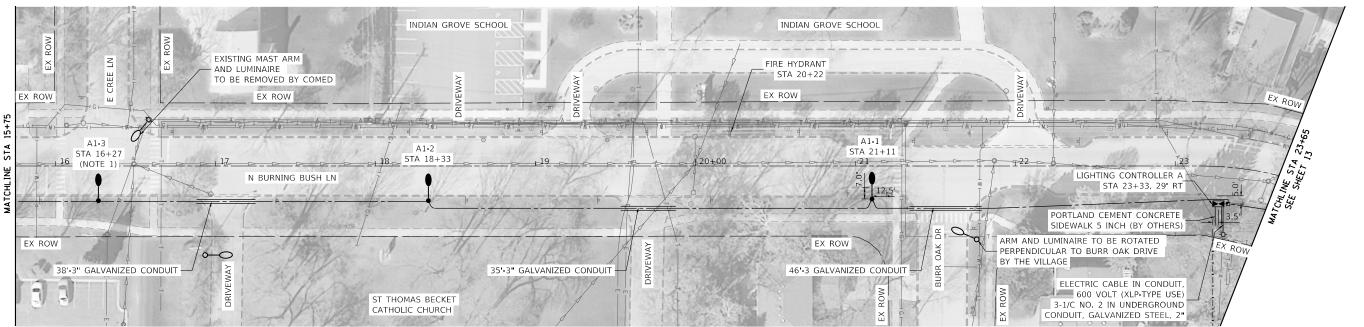


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	RTE.	SECTION	COUNTY	TOTAL SHEETS	SHEE NO.
PROPOSED LIGHTING PLAN			COOK	14	12
SCALE: 1" = 30' SHEET NO. 1 OF 2 SHEETS STA. 10+26 TO STA. 23+65		ILLINOIS FED. AI	D PROJECT		





LEGEND

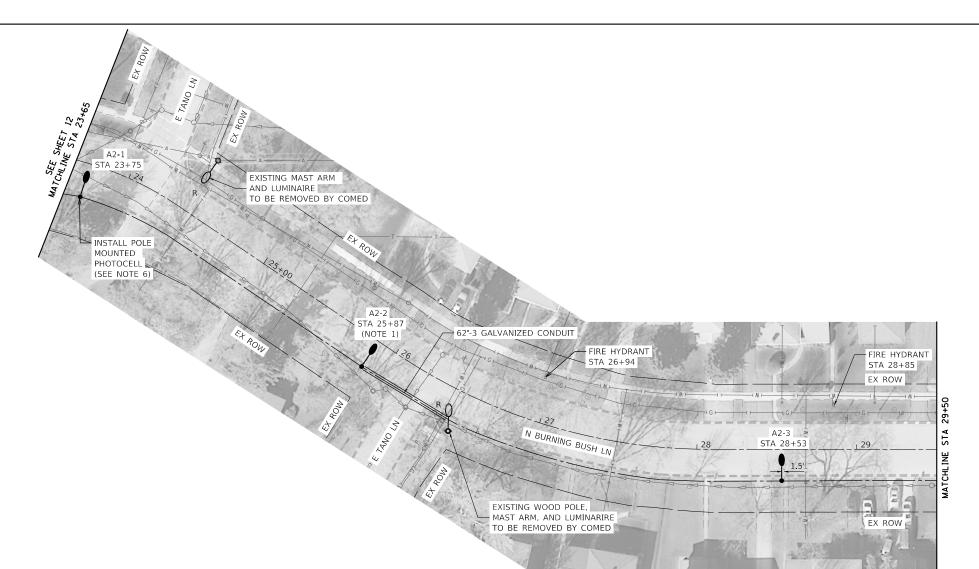O—O EXISTING LIGHT POLE AND LUMINAIRE

← R EXISTING MAST ARM AND LUMINAIRE TO BE REMOVED

 LIGHT STANDARD, 25 FT. M.H., 10 FT. CLAMP-ON MAST ARM, LED LUMINAIRE ON LIGHT POLE FOUDATION, METAL

PROPOSED HANDHOLE

PROPOSED LIGHTING CONTROLLER

 PROPOSED UNIT DUCT WITH 2-1/C No. 6 & 1-1/C No. 8 GROUND, 600V (XLP-TYPE USE), 1" DIA. OR AS NOTED


PROPOSED RIGID GALVANIZED STEEL CONDUIT


CONTROLLER IDENTIFICATION (TYP.)
CIRCUIT NUMBER (TYP.)

ÁÍ-1 --- POLE NUMBER (TYP.)

NOTE

- VILLAGE TO RELOCATE EXISTING STREET SIGNS FROM SIGN POSTS TO PROPOSED LIGHT POLES.
- 2. OFFSET LIGHTING UNITS NEAR DRIVEWAYS TO MAINTAIN 6 FEET FROM EDGE OF DRIVEWAY TO EDGE OF FOUNDATION UNLESS NOTED OTHERWISE.
- 3. LIGHTING UNIT SETBACK SHALL BE 3 FEET FROM FACE OF CURB TO CENTER OF FOUNDATION UNLESS NOTED OTHERWISE.
- 4. LUMINAIRES AT MID-BLOCK LOCATIONS SHALL HAVE OUTPUT CODE 050 AND LUMINAIRES AT INTERSECTIONS SHALL HAVE OUTPUT CODE 070.
- 5. WATERMAIN LOCATION SHALL BE VERIFIED IN THE FIELD PRIOR TO CONSTRUCTION.
- 6. POLE MOUNTED PHOTOCELL, 3-1/C #10 CABLE AND 1" DUCT INCLUDED IN THE COST OF LIGHTING CONTROLLER

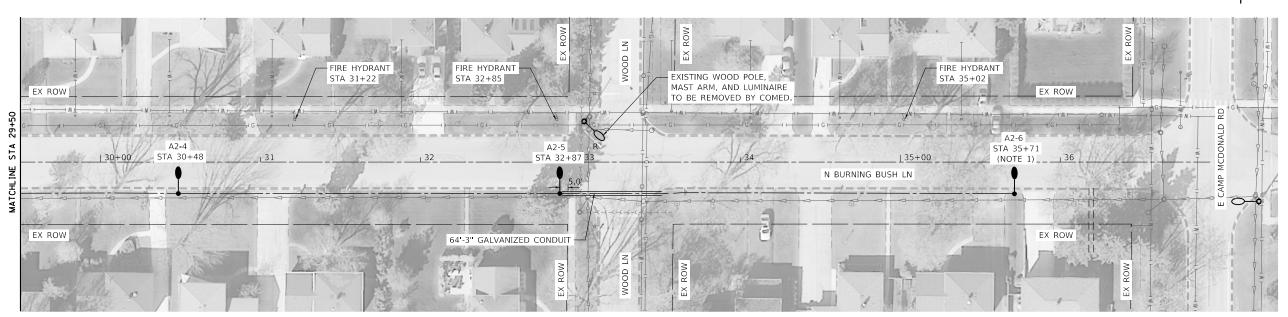

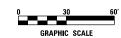

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BURNING BUSH LANE STREET LIGHTING VILLAGE OF MOUNT PROSPECT, ILLINOIS


PROPOSED LIGHTING PLAN									
SCALE: 1" = 30"	SHEET	NO.	2	OF	2	SHEETS	STA.	23+65	TO STA. 36+80

RTE.	SECTION	COUNTY	TOTAL SHEETS	SHEE NO.
		COOK	14	13
	TILINOIS EED AT	ID PROJECT		

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PLOTTED TABLE = CONFIG = NAME =



LIGHT STANDARD, ALUMINUM, 25' M.H., 10 FT. CLAMP-ON MAST ARM, WITH 66W LED LUMINAIRE

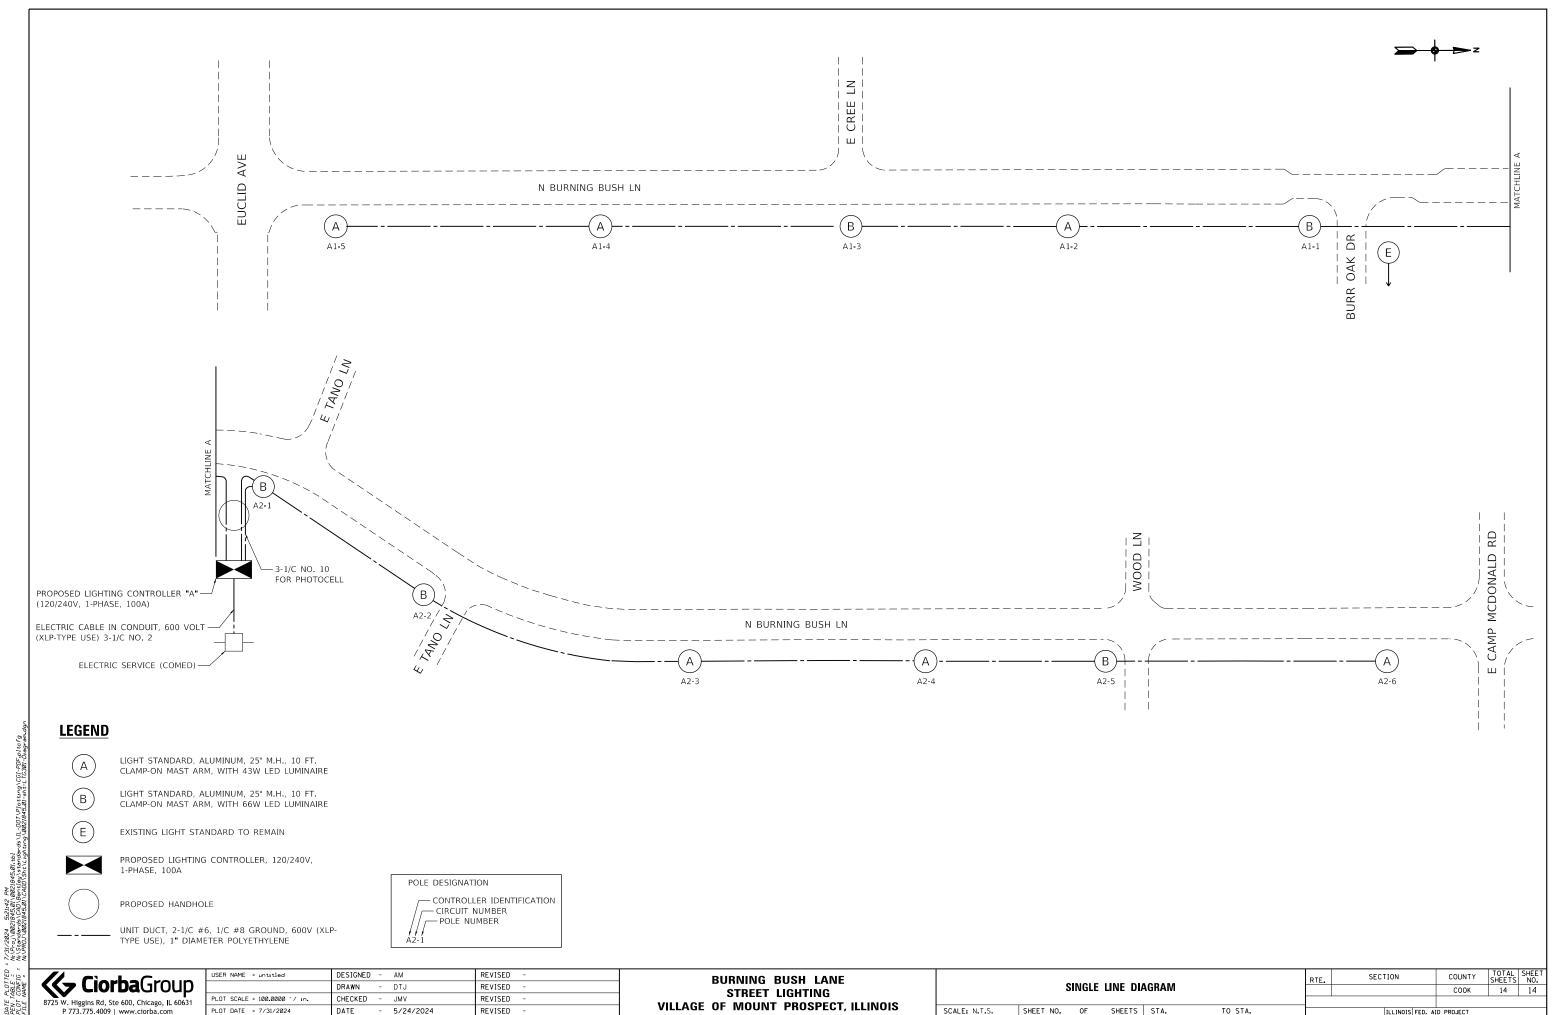EXISTING LIGHT STANDARD TO REMAIN

PROPOSED LIGHTING CONTROLLER, 120/240V, 1-PHASE, 100A

PROPOSED HANDHOLE

UNIT DUCT, 2-1/C #6, 1/C #8 GROUND, 600V (XLP-TYPE USE), 1" DIAMETER POLYETHYLENE

POLE DESIGNATION - CONTROLLER IDENTIFICATION - CIRCUIT NUMBER - POLE NUMBER

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PLOT DATE = 7/31/2024	DATE	-	5/24/2024	REVISED	-

	BURNING BUSH LANE										
STREET LIGHTING											
VILLAGE	OF MOUNT PROSPECT, ILLINOIS										

OINIOLE LINE DIAGRAM							SECTION	COUNTY	SHEETS	NO.
SINGLE LINE DIAGRAM							COOK	14	14	
SCALE: N.T.S.	SHEET NO.	OF	SHEETS	STA.	TO STA.	ILLINOIS FED. AID PROJECT				