FAIRVIEW GRAVITY SEWER VILLAGE OF MOUNT PROSPECT

IDOT HIGHWAY STANDARDS

000001-08 STANDARD SYMBOLS, ABBREVIATIONS AND PATTERNS

001001-02 AREAS OF REINFORCEMENT BARS 001006 DECIMAL OF AN INCH AND A FOOT

280001-07 TEMPORARY EROSION CONTROL SYSTEMS

353001-05 PCC BASE COURSE WITH HMA BINDER AND SURFACE COURSES

424001–11 PERPENDICULAR CURB RAMPS FOR SIDEWALKS 424026-03 ENTRANCE /ALLEY PEDESTRIAN CROSSINGS

442201-03 CLASS C AND D PATCHES

701101-05 OFF-ROAD OPERATIONS, MULTILANE 701106-02 OFF-ROAD OPERATIONS, MULTILANE 701601-09 URBAN LANE CLOSURE, MULTILANE

701602–10 URBAN LANE CLOSURE, MULTILANE

701801-06 SIDEWALK, CORNER OR CROSSWALK CLOSURE

701901–08 TRAFFIC CONTROL DEVICES

704001-08 TEMPORARY CONCRETE BARRIER

782006-01 GUARDRAIL AND BARRIER WALL REFLECTOR MOUNTING DETAILS CONCRETE CURB TYPE B AND COMBINATION CURB AND GUTTER


PROJECT LOCATION

MAYOR PAUL Wm. HOEFERT

VILLAGE CLERK KAREN AGORANOS

VILLAGE MANAGER MICHALE J. CASSADY

TRUSTEES AGOSTINO S. FILIPPONE TERRI GENS JOHN J. MATUSZAK **WILLIAM A. GROSSI** COLLEEN E. SACCOTELLI **VINCENT J. DANTE**

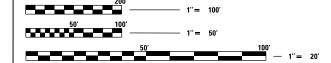

FULL SIZE PLANS HAVE BEEN PREPARED USING STANDARD ENGINEERING SCALES, REDUCED SIZED PLANS WILL NOT CONFORM TO STANDARD SCALES IN MAKING MEASUREMENTS ON REDUCED PLANS, THE ABOVE SCALES MAY BE USED

J.U.L.I.E.

800.892.0123 or 811 847.870.5640 847.870.5656

847.870.5660

MEADE ELECTRIC CO., DISTRICT ONE ELECTRICAL MAINTENANCE CONTRACTOR LOCATES IDOT ELECTRICAL EQUIPMENT AND UNDERGROUND CABLES 773.287.7872

Contact the Metropolitan Water Reclamation District of Greater Chicago 2 days before starting work.

P (708) 588-4055 **■** WMOlobStart@mwrd.org

OF FIRE HYDRANT LOCATED ALONG THE EAST SIDE OF HORNE LANE APPROXIMATELY 550' NORTH OF CENTRAL ROAD. ELEV. = 655.89

ARROW BOLT ON TOP FLANGE

BM "D" NORTH FACE OF THE CONCRETE FOUNDATION OF LIGHT POLE #51 LOCATED IN THE SOUTHWEST CORNER OF CENTRAL ROAD AND PATRICIA LANE. ELEV. = 656.94

ARROW BOLT ON TOP FLANGE OF FIRE HYDRANT LOCATED ALONG THE EAST SIDE OF HORNE LANE APPROXIMATELY 250' NORTH OF CENTRAL ROAD. ELEV. = 660.73

BM "E" SOUTH FACE OF THE CONCRETE FOUNDATION OF LIGHT POLE #54 LOCATED IN THE NORTHWEST CORNER OF CENTRAL ROAD AND STEVENSON LANE. ELEV. = 655.49

LOCATED IN THE NORTHWEST HORNE LANE ELEV. = 658.91

BM "F" SOUTHEAST BOLT LOCATED IN THE BASE OF THE MAST ARM LOCATED IN THE NORTHWEST CORNER OF CENTRAL ROAD AND WOLF ROAD. ELEV. = 655.64

PROJECT LENGTH


HORNER LANE = 614 LF CENTRAL ROAD = 970 LF

BENCHMARK (NAVD 88)

EAST FACE OF THE CONCRETE FOUNDATION OF LIGHT POLE #48 **CORNER OF CENTRAL ROAD AND**

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FAIRVIEW GRAVITY SEWER

FEBRUARY 18. 2024

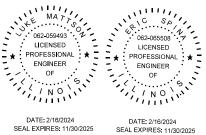SHEET 1 OF 47

GENERAL NOTES:

- . THE CONTRACTOR SHALL NOTIFY J.U.L.I.E (DIAL 1-800-892-0123) 48 HOURS PRIOR TO ANY EXCAVATION WORK TO DETERMINE THE LOCATIONS OF EXISTING UTILITIES.
- THE VILLAGE OF MOUNT PROSPECT, AND THEIR DESIGNATED AGENTS SHALL BE NOTIFIED BY THE CONTRACTOR 48 HOURS PRIOR TO STARTING CONSTRUCTION.
- 3. DO NOT SCALE DRAWINGS FOR CONSTRUCTION DIMENSIONS.
- 4. THE ENGINEER PLEDGES THE DESIGN, RECOMMENDATIONS, AND SPECIFICATIONS TO HAVE BEEN PREPARED IN ACCORDANCE WITH CONDITIONS GENERALLY ENCOUNTERED IN THE INDUSTRY. THE DESIGN ENGINEER ASSUMES NO RESPONSIBILITY WITH RESPECT TO THE DESIGN RECOMMENDATIONS AND SPECIFICATIONS FOR COMPLEX OR UNUSUAL SOIL CONDITIONS ENCOUNTERED ON THE PROJECT. IT SHALL BE THE BIDDERS' RESPONSIBILITY TO ASCERTAIN THE EXACT NATURE OF SUBSURFACE CONDITIONS PRIOR TO THE CONSTRUCTION OF THE IMPROVEMENTS.
- 5. THE LOCATION OF EXISTING UTILITIES, EASEMENTS, AND RIGHT-OF-WAYS ARE SHOWN ON THESE PLANS ACCORDING TO SURVEYS CARRIED OUT AND EXISTING VILLAGE DATA, AND REPRESENT THE BEST INFORMATION MADE POSSIBLE TO THE ENGINEER. THIS DOES NOT PRECLUDE THE EXISTENCE OF OTHER UNDERGROUND UTILITIES. THE CONTRACTOR IS RESPONSIBLE FOR VERIFICATION OF THE LOCATION OF ALL UTILITIES PRIOR TO CONSTRUCTION AND TO PROVIDE FOR THEIR PROTECTION FROM DAMAGE DURING THE CONSTRUCTION. THE CONTRACTOR SHALL BE RESPONSIBLE FOR THE REPAIR OR REPLACEMENT OF ANY UTILITY DAMAGED DURING CONSTRUCTION TO THE SATISFACTION OF THE OWNERS'S REPRESENTATIVE AT THE CONTRACTOR'S COST. IF OTHER UTILITIES OR CONFLICTS ARE ENCOUNTERED, THE CONTRACTOR SHALL NOTIFY THE ENGINEER SO THE CONFLICT CAN BE RESOLVED.
- 6. BEFORE BEGINNING CONSTRUCTION, THE CONTRACTOR SHALL VERIFY THE LINE AND GRADES SHOWN ON THE CONTRACT DRAWINGS. IF THERE ARE ANY DISCREPANCIES FROM WHAT IS SHOWN ON THE CONTRACT DRAWINGS, THE CONTRACTOR SHALL IMMEDIATELY REPORT SAME TO THE OWNER PRIOR TO PERFORMING WORK. CONTRACTOR SHALL BE RESPONSIBLE FOR COORDINATION OF WORK REQUIRED.
- ALL WORK SHALL BE IN ACCORDANCE WITH THE LATEST EDITION OF THE FOLLOWING SPECIFICATIONS, WHICH ARE HEREBY MADE A PART HEREOF:
 - A. "STANDARD SPECIFICATIONS FOR ROAD AND BRIDGE CONSTRUCTION IN ILLINOIS", LATEST EDITION.
 - B. "SUPPLEMENTAL SPECIFICATIONS AND RECURRING SPECIAL PROVISIONS", LATEST FOITION.
- C. "STANDARD SPECIFICATIONS FOR WATER AND SEWER CONSTRUCTION IN ILLINOIS", LATEST EDITION.
- D. OWNER AND CURRENT MUNICIPAL CODES.
- E. NATIONAL ELECTRIC CODE.
- 8. IT IS THE CONTRACTOR'S RESPONSIBILITY TO DETERMINE ALL MATERIAL QUANTITIES AND APPRAISE HIMSELF OF ALL CONDITIONS. THE CONTRACT PRICE SUBMITTED BY THE CONTRACTOR SHALL BE CONSIDERED AS THE TOTAL COST FOR THE COMPLETE PROJECT. NO CLAIMS FOR EXTRA WORK WILL BE RECOGNIZED DUE TO THE CONTRACTOR'S FAILURE TO UNDERSTAND THE SCOPE OF WORK.
- THE CONTRACTOR, AT HIS EXPENSE, SHALL BE RESPONSIBLE FOR OBTAINING ALL PERMITS AND BONDS FOR CONSTRUCTION ALONG OR ACROSS EXISTING ROADWAYS WITHIN THE PROJECT SITE. THE CONTRACTOR SHALL MAKE ARRANGEMENTS FOR PROPER BRACING, SHORING, OR OTHER PROTECTION REQUIRED, INCLUDING INSTALLATION AND MAINTENANCE OF ADEQUATE TRAFFIC CONTROL AND PROTECTION BEFORE CONSTRUCTION BEGINS. ALL WORK CONDUCTED SHALL BE PROTECTED IN ACCORDANCE WITH APPLICABLE PORTIONS OF THE LATEST EDITION OF THE "ILLINOIS DEPARTMENT OF TRANSPORTATION STANDARD SPECIFICATIONS FOR ROAD AND BRIDGE CONSTRUCTION" (IL STANDARD SPECIFICATIONS), SUPPLEMENTAL SPECIFICATIONS AND RECURRING SPECIAL PROVISIONS, AND THE LATEST EDITION OF THE "ILLINOIS MANUAL ON UNIFORM TRAFFIC CONTROL DEVICES" (MUTCD).
- 10. THE ENGINEER WILL NOT BE RESPONSIBLE FOR CONTRACTORS' MEANS, METHODS, TECHNIQUES, SEQUENCES, OR PROCEDURES OF CONSTRUCTION, OR THE SAFETY, PRECAUTIONS, AND PROGRAMS INCIDENT THERETO, AND THE ENGINEER WILL NOT BE RESPONSIBLE FOR CONTRACTORS' FAILURE TO PERFORM OR FURNISH THE WORK IN ACCORDANCE WITH THE CONTRACT DOCUMENTS.
- II. THE CONTRACTOR SHALL BE RESPONSIBLE FOR THE INSTALLATION AND MAINTENANCE OF ADEQUATE SIGNS AND WARNING DEVICES TO INFORM AND PROTECT THE PUBLIC. THE STANDARD SPECIFICATIONS SHALL APPLY. APPROPRIATE CONTROL METHODS SHALL BE APPLIED TO THE SPECIFIC SITUATIONS AND TYPES OF CONSTRUCTION OPERATIONS BEING PERFORMEN.
- 2. THE CONTRACTOR SHALL RESTORE SURFACES TO THE ORIGINAL PRE-CONSTRUCTION CONDITION IF DAMAGED BY CONSTRUCTION. ANY EXISTING CURB, PAVEMENT, OR SIDEWALK DISTURBED DURING THE CONSTRUCTION PROCESS IS TO BE REPLACED. UNPAVED AREAS ARE TO BE FINE GRADED AND SODDED UNLESS OTHERWISE NOTED. ALL EXCESS TRENCH MATERIAL IS TO BE REMOVED FROM THE SITE. THE COST OF SAID REPLACEMENT AND REMOVAL SHALL BE CONSIDERED INCLUDED IN THE CONTRACT.
- 13. ALL TRENCHES CAUSED BY THE CONSTRUCTION OF SEWERS, FORCEMAINS, WATERMAIN, WATER SERVICE PIPES, AND ALL EXCAVATIONS AROUND CATCH BASINS, MANHOLES, INLETS, AND OTHER APPURTENANCES WHICH OCCUR WITHIN TWO FEET OF THE LIMITS OF EXISTING AND PROPOSED PAVEMENTS, SIDEWALKS, AND CURB AND GUTTERS, SHALL BE BACKFILLED WITH SELECT GRANULAR BACKFILL (CRUSHED) (IDOT GRADATION CA-11) AND COMPACTED PROPERLY, OR AS SHOWN ON THE DETAILS. ANY DEPRESSIONS IN PAVEMENT AREAS THAT

- WERE REPLACED SHALL BE REMOVED AND CONSTRUCTED PROPERLY AT THE CONTRACTOR'S EXPENSE IN ACCORDANCE WITH THE APPROPRIATE STANDARD.
- 14. IT SHALL BE THE RESPONSIBILITY OF THE CONTRACTOR TO ABIDE BY, ADHERE TO, AND PERFORM ALL WORK IN ACCORDANCE WITH THE REQUIREMENTS, SPECIFICATIONS, STANDARDS, PRACTICES, POLICIES, AND CODES OF THE OWNER WHICH INCLUDES, BUT IS NOT LIMITED TO, LABOR, MATERIALS, PROCEDURES, AND SAFETY.
- 15. THE CONTRACTOR IS RESPONSIBLE FOR HAVING THE MOST RECENT SET OF APPROVED FINAL ENGINEERING PLANS WITH THE LATEST REVISION DATE ON THE JOB SITE PRIOR TO THE START OF CONSTRUCTION.
- 16. NO HOLES ARE TO BE LEFT OPEN IN THE PAVEMENT OR PARKWAY OVER A HOLIDAY, WEEKEND, OR AFTER COMPLETION OF THE DAY'S ACTIVITIES ON THE DAY PRECEDING A HOLIDAY OR A WEFKEND
- 17. ANY CHANGES, REVISIONS, OR SUBSTITUTIONS TO THE PLANS, SPECIFICATIONS, MATERIALS, REQUIREMENTS, OR WORK SHALL BE SUBMITTED TO THE OWNER, IN WRITING, WITH WRITTEN APPROVAL BY THE OWNER RECEIVED PRIOR TO BEGINNING SAID WORK. ALL MATERIALS AND CONSTRUCTION WHETHER IMPLICITLY OR EXPLICITLY STATED OR COVERED WITHIN THE REQUIREMENTS, CODES OR SPECIFICATIONS, SHALL BE APPROVED BY THE OWNER, PRIOR TO COMMENCING THE INSTALLATION AND CONSTRUCTION.
- 18. THE DESIGN OF PROPOSED SANITARY SEWERS AND THE LOCATIONS AND ELEVATIONS OF EXISTING UTILITIES ARE SHOWN BASED ON INTERPRETATION OF INFORMATION RECEIVED. THE CONTRACTOR IS RESPONSIBLE FOR LOCATING ALL EXISTING WATERMAIN, SANITARY AND STORM SEWER, AND UTILITIES PRIOR TO INSTALLATION OF NEW SEWER.
- 19. NO EXTRA WORK OF ANY NATURE SHALL BE UNDERTAKEN WITHOUT FIRST OBTAINING WRITTEN APPROVAL FROM THE OWNER OR HIS REPRESENTATIVE.
- 20. THE CONTRACTOR SHALL LIMIT CONSTRUCTION ACTIVITIES AND STORAGE OF EQUIPMENT OR MATERIALS TO THE DESIGNATED OR APPROVED WORK CONSTRUCTION LIMITS. ANY DAMAGE TO PRIVATE PROPERTY SHALL BE REPAIRED AT CONTRACTOR'S EXPENSE.
- 21. PROPOSED EQUIPMENT, CONDUITS, ETC. ARE SHOWN DIAGRAMMATICALLY. THE CONTRACTOR SHALL COORDINATE EXACT EQUIPMENT SIZES, LOCATIONS, ROUTING, ETC. VERIFY ALL LOCATIONS / ROUTING WITH OWNER.
- 22. ANY AND ALL DEWATERING REQUIRED TO KEEP EXCAVATIONS DRY SHALL BE THE RESPONSIBILITY OF THE CONTRACTOR. ALL SPOILS SHALL BE PROMPTLY REMOVED FROM SITE.
- 23. LIMITS OF CONSTRUCTION SHALL BE SUBJECT TO OWNER'S APPROVAL AND SHALL NOT IMPACT EXISTING ROADWAY PAVEMENT EXCEPT WHERE IMPROVEMENTS ARE SHOWN BY DRAWINGS. LIMITS OF CONSTRUCTION (OTHER THAN ACROSS ROADWAY PAVEMENT) SHALL BE

CONSTRUCTION MANAGEMENT REQUIREMENTS:

- DUMPSTERS AND PORTABLE TOILETS ARE REQUIRED. A PLAN MUST BE SUBMITTED WHICH INDICATES THE PROPOSED LOCATIONS OF THE DUMPSTER AND PORTABLE TOILET. ALL DUMPSTERS MUST BE COVERED AND ENCLOSED.
- . CONTRACTOR SHALL BE RESPONSIBLE FOR THE IMMEDIATE RESTORATION OF ALL OFF-SITE AREAS DISTURBED IN CONJUNCTION WITH THE PERMITTED CONSTRUCTION
- SIDEWALKS, PARKING LOTS, AND OTHER PUBLIC AND PRIVATE PROPERTY MUST BE KEPT SAFE AND FREE FROM MUD, DIRT, AND DEBRIS.

EROSION AND SEDIMENT CONTROL PLAN:

- 1. ANY STORM WATER DRAINAGE STRUCTURES THAT HAVE THE POTENTIAL TO ACCEPT RUNOFF CONTAINING SUSPENDED SOIL PARTICLES FROM THE LIMITS OF CONSTRUCTION SHALL HAVE INLET FILTERS INSTALLED DIRECTLY ON OR UNDER THE GRATE OF THE DRAINAGE STRUCTURE.
- EXISTING PAVEMENT SURFACES SHALL BE INSPECTED DAILY FOR SOIL DEBRIS AND SHALL BE CLEANED WHEN NECESSARY OR AS DIRECTED BY OWNER.
- DISPOSAL OF DEBRIS SHALL BE THE CONTRACTOR'S RESPONSIBILITY AND WILL NOT BE PAID FOR SEPARATELY BUT SHALL BE INCLUDED IN THE CONTRACT.
- 4. EROSION CONTROL PRACTICES SHALL BE CONSTRUCTED IN ACCORDANCE WITH ILLINOIS URBAN MANUAL, LATEST REVISION.
- . CONTRACTOR SHALL INSPECT ALL SEDIMENTATION AND EROSION CONTROL MEASURES AT LEAST ONCE EVERY SEVEN (7) DAYS AND AFTER EACH $\frac{1}{2}$ " OR GREATER RAINFALL EVENT. CONTRACTOR SHALL CLEAN AND REPAIR ITEMS WITHIN 24 HOURS OF INSPECTION AS NECESSARY TO MAINTAIN EFFECTIVE SEDIMENTATION AND EROSION CONTROL MEASURES.

LEGEND: EXISTING BUIL DINGS FIRE HYDRANT RIGHT-OF-WAY \Box POWER POLE ROADWAY PLAN-PAVED CATCH BASIN ROADWAY PLAN-UNPAVED α LIGHT POLE CENTERLINE 0 MANHOLE FASEMENT 0 EDGE OF EXISTING PAVEMENT MISCELLANEOUS POST FENCE BIT BITUMINOUS PAVEMENT TELEPHONE LINE CONCRETE PAVEMENT CONC GAS MAIN BENCHMARK ◬ WATER MAIN BORINGS ELECTRIC LINE MONITORING WELL COMBINED SEWER DECIDUOUS TREE SANITARY SEWER (3) STORM SEWER ----S/L----STREET LIGHTS SUMMIT \bigcirc VALVE VAULT DIRECTION OF DRAINAGE (3) VALVE BOX - VB TREELINE —T/S— TRAFFIC SIGNAL STREET CENTERLINE Ε VAULT (Electric Utilities) -0-TELEPHONE POLE \Box SIGN (S) PROPOSED ----- CONSTRUCTION LIMITS LINE STOP - x --- x --- x FENCE MANHOLE SILT FENCE (\$) VALVE VAULT -FM---- FORCE MAIN VALVE BOX - VB COMBINED SEWER TREE REMOVAL INLET FILTER → STORM SEWER TREE PROTECTION — W — WATER MAIN



P 773 775 4009 L www.ciorba.com

VILLAGE OF MOUNT PROSPECT

SCALE.

FAIRVIEW GRAVITY SEWER
LEGEND AND GENERAL NOTES

RTE. SECTION

COUNTY SHEETS NO.

COOK 47 2

CONTRACT NO.21782.01

- EXCEPT AS MODIFIED HEREIN OR ON THE PLANS:

 * STANDARD SPECIFICATIONS FOR ROAD AND BRIDGE CONSTRUCTION (LATEST EDITION), BY THE
 ILLINOIS DEPARTMENT OF TRANSPORTATION (IDOT SS) FOR ALL IMPROVEMENTS EXCEPT SANITARY
 SEWER AND WATER MAIN CONSTRUCTION;
- * STANDARD SPECIFICATIONS FOR WATER AND SEWER MAIN CONSTRUCTION IN ILLINOIS, LATEST EDITION (SSWS) FOR SANITARY SEWER AND WATER MAIN CONSTRUCTION;
- * VILLAGE OF MOUNT PROSPECT MUNICIPAL CODE;

 * THE METROPOLITAN WATER RECLAMATION DISTRICT OF GREATER CHICAGO (MWRD) WATERSHED
- MANAGEMENT ORDINANCE AND TECHNICAL GUIDANCE MANUAL;
 **IN CASE OF CONFLICT BETWEEN THE APPLICABLE ORDINANCES NOTED, THE MORE STRINGENT SHALL TAKE PRECEDENCE AND SHALL CONTROL ALL CONSTRUCTION.

B. NOTIFICATIONS

- THE MWRD LOCAL SEWER SYSTEMS SECTION FIELD OFFICE MUST BE NOTIFIED AT LEAST TWO (2) WORKING DAYS PRIOR TO THE COMMENCEMENT OF ANY WORK (CALL 708-588-4055 OR SEND EMAIL NOTIFICATION WITH PROJECT NAME, LOCATION AND PERMIT NUMBER TO <u>WMOJOBSTART@MWRD.ORG</u>).
- 2. THE VILLAGE OF MOUNT PROSPECT ENGINEERING DEPARTMENT AND PUBLIC MUST BE NOTIFIED AT LEAST 24 HOURS PRIOR TO THE START OF CONSTRUCTION AND PRIOR TO EACH PHASE OF WORK. CONTRACTOR SHALL DETERMINE ITEMS REQUIRING INSPECTION PRIOR TO START OF CONSTRUCTION OR EACH WORK PHASE.
- 3. THE CONTRACTOR SHALL NOTIFY ALL UTILITY COMPANIES PRIOR TO BEGINNING CONSTRUCTION FOR THE EXACT LOCATIONS OF UTILITIES AND FOR THEIR PROTECTION DURING CONSTRUCTION. IF EXISTING UTILITIES ARE ENCOUNTERED THAT CONFLICT IN LOCATION WITH NEW CONSTRUCTION, IMMEDIATELY NOTIFY THE ENGINEER SO THAT THE CONFLICT CAN BE RESOLVED. CALL J.U.L.I.E. AT 1-800-892-0123.

C. GENERAL NOTES

- 1. ALL ELEVATIONS SHOWN ON PLANS REFERENCE THE NORTH AMERICAN VERTICAL DATUM OF 1988 (NAVD88).
- 2. MWRD, THE MUNICIPALITY AND THE OWNER OR OWNER'S REPRESENTATIVE SHALL HAVE THE AUTHORITY TO INSPECT, APPROVE, AND REJECT THE CONSTRUCTION IMPROVEMENTS.
- 3. THE CONTRACTOR(S) SHALL INDEMNIFY THE OWNER, ENGINEER, MUNICIPALITY, MWRD, AND THEIR AGENTS, ETC., FROM ALL LIABILITY INVOLVED WITH THE CONSTRUCTION, INSTALLATION, OR TESTING OF THIS WORK ON THE PROJECT.
- 4. THE PROPOSED IMPROVEMENTS MUST BE CONSTRUCTED IN ACCORDANCE WITH THE ENGINEERING PLANS AS APPROVED BY MWRD AND THE MUNICIPALITY UNLESS CHANGES ARE APPROVED BY MWRD, THE MUNICIPALITY, OR AUTHORIZED AGENT. THE CONSTRUCTION DETAILS, AS PRESENTED ON THE PLANS, MUST BE FOLLOWED. PROPER CONSTRUCTION TECHNIQUES MUST BE FOLLOWED ON THE IMPROVEMENTS INDICATED ON THE PLANS.
- 5. THE LOCATION OF VARIOUS UNDERGROUND UTILITIES WHICH ARE SHOWN ON THE PLANS ARE FOR INFORMATION ONLY AND REPRESENT THE BEST KNOWLEDGE OF THE ENGINEER. VERIFY LOCATIONS AND ELEVATIONS PRIOR TO BEGINNING THE CONSTRUCTION OPERATIONS.
- 6. ANY EXISTING PAVEMENT, SIDEWALK, DRIVEWAY, ETC., DAMAGED DURING CONSTRUCTION OPERATIONS AND NOT CALLED FOR TO BE REMOVED SHALL BE REPLACED AT THE EXPENSE OF THE CONTRACTOR.
- 7. MATERIAL AND COMPACTION TESTING SHALL BE PERFORMED IN ACCORDANCE WITH THE REQUIREMENTS OF THE MUNICIPALITY, MWRD, AND OWNER.
- 8. THE UNDERGROUND CONTRACTOR SHALL MAKE ALL NECESSARY ARRANGEMENTS TO NOTIFY ALL INSPECTION AGENCIES.
- 9. ALL NEW AND EXISTING UTILITY STRUCTURES ON SITE AND IN AREAS DISTURBED DURING CONSTRUCTION SHALL BE ADJUSTED TO FINISH GRADE PRIOR TO FINAL INSPECTION.
- 10. RECORD DRAWINGS SHALL BE KEPT BY THE CONTRACTOR AND SUBMITTED TO THE ENGINEER AS SOON AS UNDERGROUND IMPROVEMENTS ARE COMPLETED. FINAL PAYMENTS TO THE CONTRACTOR SHALL BE HELD UNTIL THEY ARE RECEIVED. ANY CHANGES IN LENGTH, LOCATION OR ALIGNMENT SHALL BE SHOWN IN RED. ALL WYES OR BENDS SHALL BE LOCATED FROM THE DOWNSTREAM MANHOLE. ALL VALVES, B-BOXES, TEES OR BENDS SHALL BE TIED TO A FIRE HYDRANT.

D. SANITARY SEWER

- 1. THE CONTRACTOR SHALL TAKE MEASURES TO PREVENT ANY POLLUTED WATER, SUCH AS GROUND AND SURFACE WATER, FROM ENTERING THE EXISTING SANITARY SEWERS.
- A WATER-TIGHT PLUG SHALL BE INSTALLED IN THE DOWNSTREAM SEWER PIPE AT THE POINT OF SEWER CONNECTION PRIOR TO COMMENCING ANY SEWER CONSTRUCTION. THE PLUG SHALL REMAIN IN PLACE UNTIL REMOVAL IS AUTHORIZED BY THE MUNICIPALITY AND/OR MWRD AFTER THE SEWERS HAVE BEEN TESTED AND ACCEPTED.
- 3. DISCHARGING ANY UNPOLLUTED WATER INTO THE SANITARY SEWER SYSTEM FOR THE PURPOSE OF SEWER FLUSHING OF LINES FOR THE DEFLECTION TEST SHALL BE PROHIBITED WITHOUT PRIOR APPROVAL
- ALL SANITARY SEWER CONSTRUCTION SHALL BE IN ACCORDANCE WITH THE STANDARD SPECIFICATIONS FOR WATER AND SEWER MAIN CONSTRUCTION IN ILLINOIS (LATEST EDITION).
- 5. ALL FLOOR DRAINS SHALL DISCHARGE TO THE SANITARY SEWER SYSTEM.
- 6. ALL DOWNSPOUTS AND FOOTING DRAINS SHALL DISCHARGE TO THE STORM SEWER SYSTEM.
- 7. ALL SANITARY SEWER PIPE MATERIALS AND JOINTS (AND STORM SEWER PIPE MATERIALS AND JOINTS IN A COMBINED SEWER AREA) SHALL CONFORM TO THE FOLLOWING:

PIPE MATERIAL	PIPE SPECIFICATIONS	JOINT SPECIFICATIONS
VITRIFIED CLAY PIPE	ASTM C-700	ASTM C-425
REINFORCED CONCRETE SEWER PIPE	ASTM C-76	ASTM C-443
CAST IRON SOIL PIPE	ASTM A-74	ASTM C-564
DUCTILE IRON PIPE	ANSI A21.51	ANSI A21.11
POLYVINYL CHLORIDE (PVC) PIPE 6-INCH TO 15-INCH DIAMETER SDR 26 18-INCH TO 27-INCH DIAMETER F/DY=46	ASTM D-3034 ASTM F-679	ASTM D-3212 ASTM D-3212
HIGH DENSITY POLYETHYLENE (HDPE)	ASTM D-3350 ASTM D-3035	ASTM D-3261,F-2620 (HEAT FUSION) ASTM D-3212,F-477 (GASKETED)
WATER MAIN QUALITY PVC 4-INCH TO 36-INCH 4-INCH TO 12-INCH 14-INCH TO 48-INCH	ASTM D-2241 AWWA C900 AWWA C905	ASTM D-3139 ASTM D-3139 ASTM D-3139

THE FOLLOWING MATERIALS ARE ALLOWED ON A QUALIFIED BASIS SUBJECT TO DISTRICT REVIEW AND APPROVAL PRIOR TO PERMIT ISSUANCE. A SPECIAL CONDITION WILL BE ADDED TO THE PERMIT WHEN THE PIPE MATERIAL BELOW IS USED FOR SEWER CONSTRUCTION OR A CONNECTION IS MADE.

<u>PIPE MATERIAL</u> POLYPROPYLENE (PP) PIPE	PIPE SPECIFICATIONS	JOINT SPECIFICATIONS
12-INCH TO 24-INCH DOUBLE WALL	ASTM F-2736	D-3212, F-477
30-INCH TO 60-INCH TRIPLE WALL	ASTM F-2764	D3212, F-477

- 8. ALL SANITARY SEWER CONSTRUCTION (AND STORM SEWER CONSTRUCTION IN COMBINED SEWER AREAS), REQUIRES STONE BEDDING WITH STONE ¼ "TO 1" IN SIZE, WITH MINIMUM BEDDING THICKNESS EQUAL TO ¼ THE OUTSIDE DIAMETER OF THE SEWER PIPE, BUT NOT LESS THAN FOUR (4) INCHES NOR MORE THAN EIGHT (8) INCHES. MATERIAL SHALL BE CA-7, CA-11 OR CA-13 AND SHALL BE EXTENDED AT LEAST 12" ABOVE THE TOP OF THE PIPE WHEN USING PVC.
- 9. NON-SHEAR FLEXIBLE-TYPE COUPLINGS SHALL BE USED IN THE CONNECTION OF SEWER PIPES OF DISSIMILAR PIPE MATERIALS.
- 10. ALL MANHOLES SHALL BE PROVIDED WITH BOLTED, WATERTIGHT COVERS. SANITARY LIDS SHALL BE CONSTRUCTED WITH A CONCEALED PICKHOLE AND WATERTIGHT GASKET WITH THE WORD "SANITARY" CAST INTO THE LID
- 11. WHEN CONNECTING TO AN EXISTING SEWER MAIN BY MEANS OTHER THAN AN EXISTING WYE, TEE, OR AN EXISTING MANHOLE, ONE OF THE FOLLOWING METHODS SHALL BE USED:
- a) A CIRCULAR SAW-CÚT OF SEWER MAIN BY PROPER TOOLS ("SHEWER-TAP" MACHINE OR SIMILAR)
 AND PROPER INSTALLATION OF HUBWYE SADDLE OR HUB-TEE SADDLE.
- b) REMOVE AN ENTIRE SECTION OF PIPE (BREAKING ONLY THE TOP OF ONE BELL) AND REPLACE WITH A WYE OR TEE BRANCH SECTION.
- c) WITH PIPE CUTTER, NEATLY AND ACCURATELY CUT OUT DESIRED LENGTH OF PIPE FOR INSERTION OF PROPER FITTING, USING "BAND SEAL" OR SIMILAR COUPLINGS TO HOLD IT FIRMLY IN PLACE.
- 12. WHENEVER A SANITARY/COMBINED SEWER CROSSES UNDER A WATERMAIN, THE MINIMUM VERTICAL DISTANCE FROM THE TOP OF THE SEWER TO THE BOTTOM OF THE WATERMAIN SHALL BE 18 INCHES. FURTHERMORE, A MINIMUM HORIZONTAL DISTANCE OF 10 FEET BETWEEN SANITARY/COMBINED SEWERS AND WATERMAINS SHALL BE MAINTAINED UNLESS: THE SEWER IS LAID IN A SEPARATE TRENCH, KEEPING A MINIMUM 18" VERTICAL SEPARATION; OR THE SEWER IS LAID IN THE SAME TRENCH WITH THE WATERMAIN LOCATED AT THE OPPOSITE SIDE ON A BENCH OF UNDISTURBED EARTH, KEEPING A MINIMUM 18" VERTICAL SEPARATION. IF EITHER THE VERTICAL OR HORIZONTAL DISTANCES DESCRIBED CANNOT BE MAINTAINED, OR THE SEWER CROSSES ABOVE THE WATER MAIN, THE SEWER SHALL BE CONSTRUCTED TO WATER MAIN STANDARDS OR IT SHALL BE ENCASED WITH A WATER MAIN QUALITY CARRIER PIPE WITH THE ENDS SEALED.
- 13. ALL EXISTING SEPTIC SYSTEMS SHALL BE ABANDONED. ABANDONED TANKS SHALL BE FILLED WITH GRANUI AR MATERIAL OR REMOVED.
- 14. ALL SANITARY MANHOLES, (AND STORM MANHOLES IN COMBINED SEWER AREAS), SHALL HAVE A MINIMUM INSIDE DIAMETER OF 48 INCHES, AND SHALL BE CAST IN PLACE OR PRE-CAST REINFORCED CONCRETE.
- 15. ALL SANITARY MANHOLES, (AND STORM MANHOLES IN COMBINED SEWER AREAS), SHALL HAVE PRECAST "RUBBER BOOTS" THAT CONFORM TO ASTM C-923 FOR ALL PIPE CONNECTIONS. PRECAST SECTIONS SHALL CONSIST OF MODIFIED GROOVE TONGUE AND RUBBER GASKET TYPE JOINTS.
- 16. ALL ABANDONED SANITARY SEWERS SHALL BE PLUGGED AT BOTH ENDS WITH AT LEAST 2 FEET LONG NON-SHRINK CONCRETE OR MORTAR PLUG.
- 17. EXCEPT FOR FOUNDATION/FOOTING DRAINS PROVIDED TO PROTECT BUILDINGS, OR PERFORATED PIPES ASSOCIATED WITH VOLUME CONTROL FACILITIES, DRAIN TILES/FIELD TILES/UNDERDRAINS/PERFORATED PIPES ARE NOT ALLOWED TO BE CONNECTED TO OR TRIBUTARY TO COMBINED SEWERS, SANITARY SEWERS, OR STORM SEWERS TRIBUTARY TO COMBINED SEWERS IN COMBINED SEWER AREAS. CONSTRUCTION OF NEW FACILITIES OF THIS TYPE IS PROHIBITED; AND ALL EXISTING DRAIN TILES AND PERFORATED PIPES ENCOUNTERED WITHIN THE PROJECT AREA SHALL BE PLUGGED OR REMOVED, AND SHALL NOT BE CONNECTED TO COMBINED SEWERS, SANITARY SEWERS, OR STORM SEWERS TRIBUTARY TO COMBINED SEWERS.
- 18. A BACKFLOW PREVENTER IS REQUIRED FOR ALL DETENTION BASINS TRIBUTARY TO COMBINED SEWERS. REQUIRED BACKFLOW PREVENTERS SHALL BE INSPECTED AND EXERCISED ANNUALLY BY THE PROPERTY OWNER TO ENSURE PROPER OPERATION, AND ANY NECESSARY MAINTENANCES SHALL BE PERFORMED TO ENSURE FUNCTIONALITY. IN THE EVENT OF A SEWER SURCHARGE INTO AN OPEN DETENTION BASIN TRIBUTARY TO COMBINED SEWERS, THE PERMITTEE SHALL ENSURE THAT CLEAN UP AND WASH OUT OF SEWAGE TAKES PLACE WITHIN 48 HOURS OF THE STORM EVENT.

E. EROSION AND SEDIMENT CONTROL

- 1. THE CONTRACTOR SHALL INSTALL THE EROSION AND SEDIMENT CONTROL DEVICES AS SHOWN ON THE APPROVED EROSION AND SEDIMENT CONTROL PLAN.
- EROSION AND SEDIMENT CONTROL PRACTICES SHALL BE FUNCTIONAL PRIOR TO HYDROLOGIC DISTURBANCE OF THE SITE.
- 3. ALL DESIGN CRITERIA, SPECIFICATIONS, AND INSTALLATION OF EROSION AND SEDIMENT CONTROL PRACTICES SHALL BE IN ACCORDANCE WITH THE ILLINOIS URBAN MANUAL.
- 4. A COPY OF THE APPROVED EROSION AND SEDIMENT CONTROL PLAN SHALL BE MAINTAINED ON THE SITE AT ALL TIMES.
- 5. INSPECTIONS AND DOCUMENTATION SHALL BE PERFORMED, AT A MINIMUM:
 a) UPON COMPLETION OF INITIAL EROSION AND SEDIMENT CONTROL MEASURES, PRIOR TO ANY SOIL DISTURBANCE.
 - b) ONCE EVERY SEVEN (7) CALENDAR DAYS AND WITHIN 24 HOURS OF THE END OF A STORM EVENT WITH GREATER THAN 0.5 INCH OF RAINFALL OR LIQUID EQUIVALENT PRECIPITATION.
- 6. SOIL DISTURBANCE SHALL BE CONDUCTED IN SUCH A MANNER AS TO MINIMIZE EROSION.
 IF STRIPPING, CLEARING, GRADING, OR LANDSCAPING ARE TO BE DONE IN PHASES, THE CO-PERMITTEE SHALL PLAN FOR APPROPRIATE SOIL EROSION AND SEDIMENT CONTROL MEASURES.
- 7. A STABILIZED MAT OF CRUSHED STONE MEETING THE STANDARDS OF THE ILLINOIS URBAN MANUAL SHALL BE INSTALLED AT ANY POINT WHERE TRAFFIC WILL BE ENTERING OR LEAVING A CONSTRUCTION SITE. SEDIMENT OR SOIL REACHING AN IMPROVED PUBLIC RIGHT-OF-WAY, STREET, ALLEY OR PARKING AREA SHALL BE REMOVED BY SCRAPING OR STREET CLEANING AS ACCUMULATIONS WARRANT AND TRANSPORTED TO A CONTROLLED SEDIMENT DISPOSAL AREA.
- 8. CONCRETE WASHOUT FACILITIES SHALL BE CONSTRUCTED IN ACCORDANCE WITH THE ILLINOIS URBAN MANUAL AND SHALL BE INSTALLED PRIOR TO ANY ON SITE CONSTRUCTION ACTIVITIES INVOLVING CONCRETE
- 9. MORTAR WASHOUT FACILITIES SHALL BE CONSTRUCTED IN ADDITION TO CONCRETE WASHOUT FACILITIES FOR ANY BRICK AND MORTAR BUILDING ENVELOPE CONSTRUCTION ACTIVITIES.
- 10. TEMPORARY DIVERSIONS SHALL BE CONSTRUCTED AS NECESSARY TO DIRECT ALL RUNOFF FROM HYDROLOGICALLY DISTURBED AREAS TO AN APPROPRIATE SEDIMENT TRAP OR BASIN. VOLUME CONTROL FACILITIES SHALL NOT BE USED AS TEMPORARY SEDIMENT BASINS.
- 11. DISTURBED AREAS OF THE SITE WHERE CONSTRUCTION ACTIVITIES HAVE TEMPORARILY OR PERMANENTLY CEASED SHALL BE STABILIZED WITH TEMPORARY OR PERMANENT MEASURES WITHIN SEVEN (7) DAYS.
- ALL FLOOD PROTECTION AREAS AND VOLUME CONTROL FACILITIES SHALL, AT A MINIMUM, BE PROTECTED WITH A DOUBLE-ROW OF SILT FENCE (OR EQUIVALENT).
- 13. VOLUME CONTROL FACILITIES SHALL NOT BE CONSTRUCTED UNTIL ALL OF THE CONTRIBUTING DRAINAGE AREA HAS BEEN STABILIZED.
- 14. SOIL STOCKPILES SHALL, AT A MINIMUM, BE PROTECTED WITH PERIMETER SEDIMENT CONTROLS. SOIL STOCKPILES SHALL NOT BE PLACED IN FLOOD PROTECTION AREAS OR THEIR BUFFERS.
- 15. EARTHEN EMBANKMENT SIDE SLOPES SHALL BE STABILIZED WITH APPROPRIATE EROSION CONTROL BI ANKET.
- 16. STORM SEWERS THAT ARE OR WILL BE FUNCTIONING DURING CONSTRUCTION SHALL BE PROTECTED BY APPROPRIATE SEDIMENT CONTROL MEASURES.
- 17. THE CONTRACTOR SHALL EITHER REMOVE OR REPLACE ANY EXISTING DRAIN TILES AND INCORPORATE THEM INTO THE DRAINAGE PLAN FOR THE DEVELOPMENT. DRAIN TILES CANNOT BE TRIBUTARY TO A SANITARY OR COMBINED SEWER. DRAIN TILES ALLOWED IN COMBINED SEWER AREA FOR GREEN INFRASTRUCTURE PRACTICES.
- 18. IF DEWATERING SERVICES ARE USED, ADJOINING PROPERTIES AND DISCHARGE LOCATIONS SHALL BE PROTECTED FROM EROSION AND SEDIMENTATION. DEWATERING SYSTEMS SHOULD BE INSPECTED DAILY DURING OPERATIONAL PERIODS. THE SITE INSPECTOR MUST BE PRESENT AT THE COMMENCEMENT OF DEWATERING ACTIVITIES.
- 19. THE CONTRCTOR SHALL BE RESPONSIBLE FOR TRENCH DEWATERING AND EXCAVATION FOR THE INSTALLATION OF SANITARY SEWERS, STORM SEWERS, WATERMAINS AS WELL AS THEIR SERVICES AND OTHER APPURTENANCES. ANY TRENCH DEWATERING, WHICH CONTAINS SEDIMENT SHALL PASS THROUGH A SEDIMENT SETTLING POND OR EQUALLY EFFECTIVE SEDIMENT CONTROL DEVICE. ALTERNATIVES MAY INCLUDE DEWATERING INTO A SUMP PIT, FILTER BAG OR EXISTING VEGETATED UPSLOPE AREA. SEDIMENT LADEN WATERS SHALL NOT BE DISCHARGE TO WATERWAYS, FLOOD PROTECTION AREAS OR THE COMBINED SEWER SYSTEM.
- 20. ALL PERMANENT EROSION CONTROL PRACTICES SHALL BE INITIATED WITHIN SEVEN (7) DAYS FOLLOWING THE COMPLETION OF SOIL DISTURBING ACTIVITIES.
- 21. ALL EROSION AND SEDIMENT CONTROL MEASURES SHALL BE MAINTAINED AND REPAIRED AS NEEDED ON A YEAR-ROUND BASIS DURING CONSTRUCTION AND ANY PERIODS OF CONSTRUCTION SHUTDOWN UNTIL PERMANENT STABILIZATION IS ACHIEVED.
- 22. ALL TEMPORARY EROSION AND SEDIMENT CONTROL MEASURES SHALL BE REMOVED WITHIN THIRTY (30) DAYS AFTER PERMANENT SITE STABILIZATION.
- 23. THE EROSION AND SEDIMENT CONTROL MEASURES SHOWN ON THE PLANS ARE THE MINIMUM REQUIREMENTS. ADDITIONAL MEASURES MAY BE REQUIRED, AS DIRECTED BY THE ENGINEER, SITE INSPECTOR, OR MWRD.

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USER NAME = WaterResources	DESIGNED -	REVISED -
	DRAWN -	REVISED -
PLOT SCALE = 2.0000 ' / in.	CHECKED -	REVISED -
PLOT DATE = 2/16/2024	DATE - 2/18/2024	REVISED -

VILLAGE	0F	MOUNT	PROSPECT	

SCALE.

P	CODE NO.	ITEM	UNIT	TOTAL
	70600251	IMPACT ATTENUATORS, TEMPORARY (NON- REDIRECTIVE, NARROW), TEST LEVEL 3	EACH	2
	78000400	THERMOPLASTIC PAVEMENT MARKING - LINE 6"	FOOT	72
	78000600	THERMOPLASTIC PAVEMENT MARKING - LINE 12"	FOOT	24
	78000650	THERMOPLASTIC PAVEMENT MARKING - LINE 24"	FOOT	14
	78001100	PAINT PAVEMENT MARKING - LETTERS AND SYMBOLS	SQ FT	271
	78001110	PAINT PAVEMENT MARKING - LINE 4"	FOOT	4,104
	78001130	PAINT PAVEMENT MARKING - LINE 6"	FOOT	326
	78001150	PAINT PAVEMENT MARKING - LINE 12"	FOOT	102
	78008210	POLYUREA PAVEMENT MARKING TYPE I - LINE 4"	FOOT	340
	78008250	POLYUREA PAVEMENT MARKING TYPE I - LINE 12"	FOOT	66
	78200011	BARRIER WALL REFLECTORS, TYPE C	EACH	64
	78300202	PAVEMENT MARKING REMOVAL - WATER BLASTING	SQ FT	2,751
	85000200	MAINTENANCE OF EXISTING TRAFFIC SIGNAL INSTALLATION	EACH	1
•	Z0004510	HOT-MIX ASPHALT DRIVEWAY PAVEMENT, 3"	SQ YD	22
•	Z0013798	CONSTRUCTION LAYOUT	L SUM	1
•	Z0018911	DRILL AND GROUT #6 TIE BARS	EACH	1,935
•	Z0030850	TEMPORARY INFORMATION SIGNING	SQ FT	52
•	Z0057100	SANITARY SEWER 12"	FOOT	2,059
•	Z0073510	TEMPORARY TRAFFIC SIGNAL TIMING	EACH	1
•	X4022000	TEMPORARY ACCESS (COMMERCIAL ENTRANCE)	EACH	4

TO STA. -

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PLOT DATE = 2/16/2024	DATE	-	2/18/2024	REVISED	-

	FAIRVIEW GRAVITY SEWER
	SUMMARY OF QUANTITIES
SCALE, NITS	SHEET NO 1 OF 2 SHEETS STA -

RTE.	SECTION	COUNTY	TOTAL SHEETS	SHEE
		соок	47	4
	ILLINOIS FED. A	ID PROJECT		

SP	CODE NO.	ITEM	UNIT	TOTAL
*	X4023000	TEMPORARY ACCESS (ROAD)	EACH	2
		MANUAL EQUIPARIA AL DIAMETER, TYPE 4 EDAME		
*	X6022810	MANHOLES, SANITARY, 4'-DIAMETER, TYPE 1 FRAME, CLOSED LID	EACH	5
*	X7010216	TRAFFIC CONTROL AND PROTECTION, (SPECIAL)	L SUM	1
	7.7010210	110 0 110 0 0 1110 120 110 11, (01 20 11.12)	2 33111	·
*	XX003424	CONNECTION TO EXISTING STRUCTURE	EACH	1
*	XX003668	PRECONSTRUCTION VIDEO TAPING	L SUM	1
*	XX005696	SEWER CONNECTIONS TO STRUCTURES	EACH	2
*	XX009049	REMOVE AND REPLACE CURB AND GUTTER (SPECIAL)	FOOT	1,742
*	XX104100	CONNECTION TO EXISTING MANHOLE	EACH	1
ala.				
*	MP01	PORTLAND CEMENT CONCRETE SIDEWALK, SPECIAL	SQ FT	22
*	MP02	LIFT STATION DEMOLITION	L SUM	1


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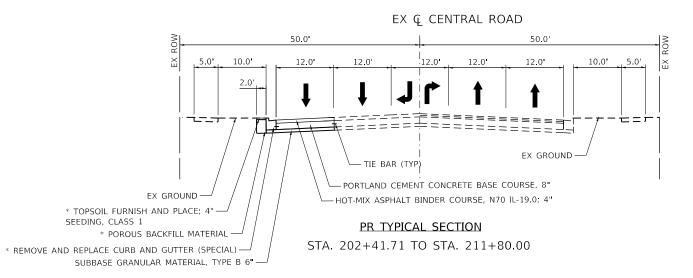
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PLOT DATE = 2/16/2024	DATE - 2/18/2024	REVISED -


VILLAGE OF MOUNT PROSPECT


FAIRVIEW GRAVITY SEWER						SECTION	COUNTY	TOTAL SHEETS	SHEET NO.
	SUMMARY OF QU			СООК	47	5			
SCALE: N.T.S.	SHEET NO. 2 OF 2 SHEETS	STA	TO STA.	-		ILLINOIS FED.	AID PROJECT		

N. N-o. v 8021782, 81 v 8021782, 81 t.b.l N. V. Standards V. GAD V. Bantaly standards VIL - DOT v Plotting V. CGI-PDF.,pl Nr. V PROJ V 8021782, 81 C. GAD V. Sht. V Nr. SS Sheets v 8021782, 81-500. dgn



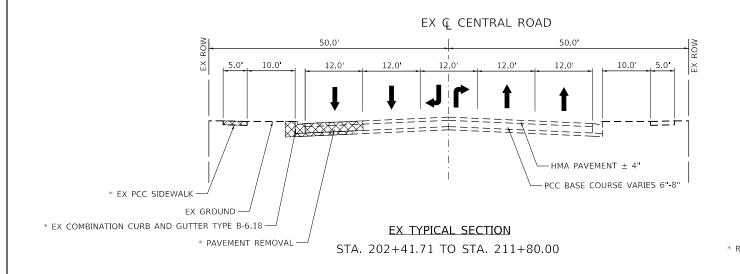

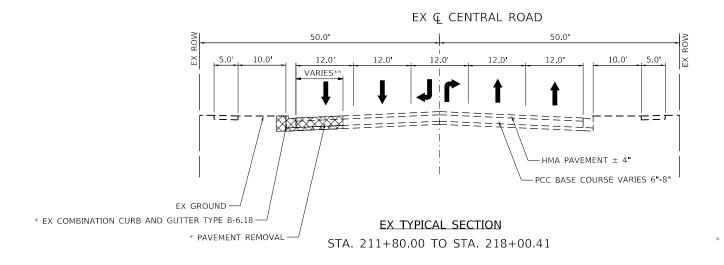

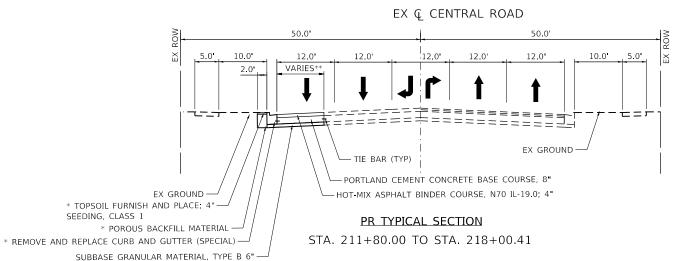

MIXTURE TYPE	PERCENT AIR VOIDS		
PAVEMENT RESTORATION			
HOT-MIX ASPHALT BINDER COURSE, IL-19.0, N70; 4"	4% @ 70 GYR.		
CLASS D PATCHES, TYPE IV, 6"			
HOT-MIX ASPHALT BINDER COURSE, IL-19.0, N70; 4"	4% @ 70 GYR.		

- REMOVAL
- * AT LOCATIONS AS SHOWN ON THE PLANS OR APPROVED BY THE ENGINEER
- ** SEE PLANS FOR DIMENSIONS

- 1. THE UNIT WEIGHT USED TO CALCULATE ALL HMA SURFACE MIXTURE QUANTITIES IS 112 LBS/SQ YD/IN.
- THE "AC TYPE" FOR POLYMERIZED HMA MIXES SHALL BE "SBS/SBR PG 76-22" AND FOR NON POLYMERIZED HMA THE "AC TYPE" SHALL BE "PG 64-22" UNLESS MODIFIED BY SPECIAL PROVISIONS.


// Charles Custon	Ē
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VILLAGE OF MOUNT PROSPECT	VILLAGE	0F	MOUNT	PROSPECT	
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SCALE:

FAIRVIEW GRAVITY SEWER TYPICAL SECTIONS					RTE.	SECTION	COUNTY	TOTAL SHEETS	SHEET NO.	
							COOK	47	6	
	ITPICAL SECTIONS							CONTRACT	NO217	82.01
	SHEET NO.	OF	SHEETS	STA.	TO STA.		ILLINOIS FED. A	ID PROJECT		



REMOVAL

 * AT LOCATIONS AS SHOWN ON THE PLANS OR APPROVED BY THE ENGINEER ** SEE PLANS FOR DIMENSIONS
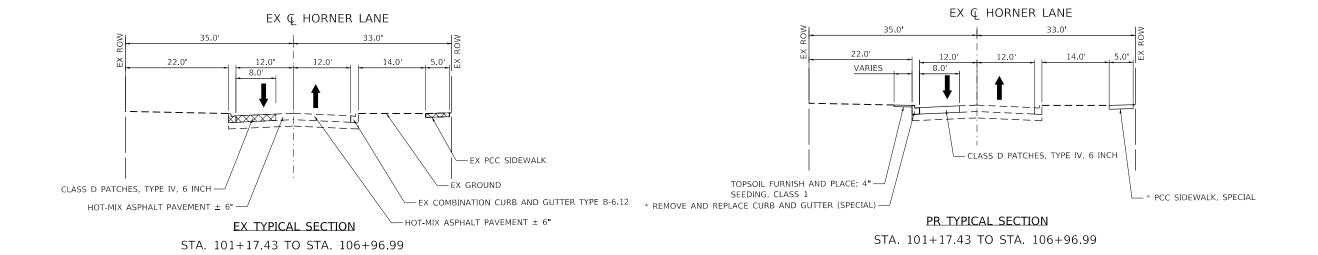
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PLOT DATE = 2/16/2024	DATE	-	2/18/2024	REVISED -

VILLAGE	0F	MOUNT	PROSPECT

SCALE:

FAIRVIEW GRAVITY SEWER						RTE.	SECTION	COUNTY	TOTAL SHEETS	SHEE.
TYPICAL SECTIONS							COOK	47	7	
	TITICAL SECTIONS							CONTRACT	NO217	82.01
	SHEET NO.	OF	SHEETS	STA.	TO STA.		ILLINOIS FED. A	D PROJECT		

PROJECT COORDINATES

CENTRAL ROAD - EXISTING ALIGNMENT									
DESCRIPTION STATION NORTHING EASTING									
P.O.T.	195+00.00	1,966,973.03	1,097,525.47						
P.I.	203+99.45	1,966,971.51	1,098,424.92						
P.I.	213+99.41	1,966,968.35	1,099,424.87						
P.O.T.	226+67.23	1,966,965.60	1,100,692.69						

PROJECT COORDINATES

HORNER LANE - EXISTING ALIGNMENT							
DESCRIPTION	STATION	NORTHING	EASTING				
P.O.T.	98+00.00	1,967,908.11	1,098,334.23				
P.I.	103+38.42	1,967,369.69	1,098,336.63				
P.I.	105+90.40	1,967,117.72	1,098,337.67				
P.I.	106+75.90	1,967,032.22	1,098,338.11				
P.O.T.	107+36.46	1,966,971.66	1,098,338.01				


PROJECT COORDINATES


WOLF ROAD - EXISTING ALIGNMENT							
	DESCRIPTION	STATION	NORTHING	EASTING			
	P.O.T.	300+00.00	1,966,967.50	1,099,819.32			
	P.O.T.	305+00.00	1,967,467.49	1,099,816.84			
	P.O.T.	310+00.00	1,967,967.48	1,099,814.37			

PROJECT BENCHMARKS

HORNER LANE							
PT#	PT# STATION OFFSET ELEV		ELEV	DESCRIPTION			
BM "A"	101+67.83	25.7 LT	655.89	ARROW BOLT ON TOP FLANGE OF FIRE HYDRANT LOCATED ALONG THE EAST SIDE OF HORNER LANE APPROXIMATELY 550' NORTH OF CENTRAL ROAD.			
BM "B"	104+60.98	25.2 LT	660.73	ARROW BOLT ON TOP FLANGE OF FIRE HYDRANT LOCATED ALONG THE EAST SIDE OF HORNER LANE APPROXIMATELY 250° NORTH OF CENTRAL ROAD.			

	CENTRAL ROAD							
PT#	STATION	OFFSET	ELEV	DESCRIPTION				
вм "с"	202+65.26	38.3 LT	658.91	EAST FACE OF THE CONCRETE FOUNDATION OF LIGHT POLE #48 LOCATED IN THE NORTHWEST CORNER OF CENTRAL ROAD AND HORNE LANE.				
BM "D"	205+84.63	40.2 RT	656.94	NORTH FACE OF THE CONCRETE FOUNDATION OF LIGHT POLE #5 LOCATED IN THE SOUTHWEST CORNER OF CENTRAL ROAD AND PATRICIA LANE.				
BM "E"	209+30.08	37.1 LT	655.49	SOUTH FACE OF THE CONCRETE FOUNDATION OF LIGHT POLE #5 LOCATED IN THE NORTHWEST CORNER OF CENTRAL ROAD AND STEVENSON LANE.				
BM "F"	217+09.50	43.3 LT	655.64	SOUTHEAST BOLT LOCATED IN THE BASE OF THE MAST ARM LOCATED IN THE NORTHWEST CORNER OF CENTRAL ROAD AND WOLF ROAD.				

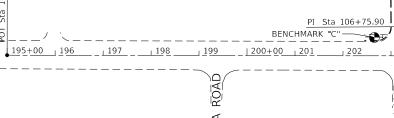

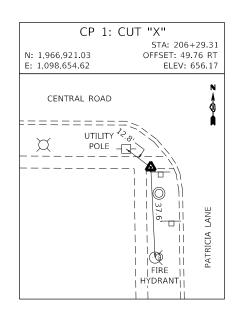

POT Sta 98+00.00

- CONTROL POINT 15

EX & HORNER LANE


-BENCHMARK "A"

BENCHMARK "B"

FI Sta 103+38.42

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HORNER LANE

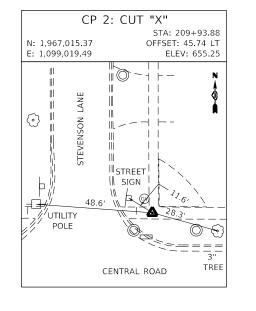

CP 16: CUT "X"

N: 1,967,332.38 E: 1,098,311.47


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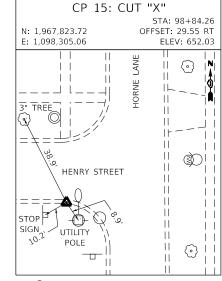
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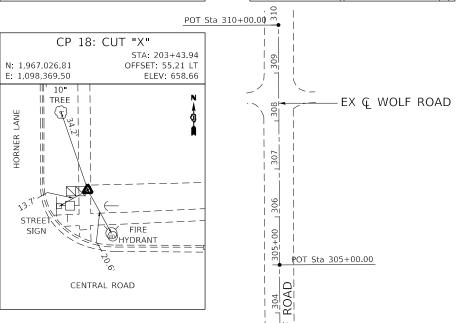
STA: 103+75.63 OFFSET: 25.31 RT


ELEV: 656.74

SCALE:





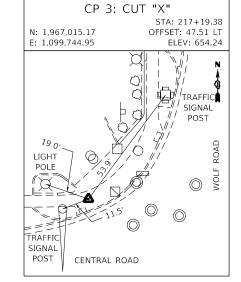

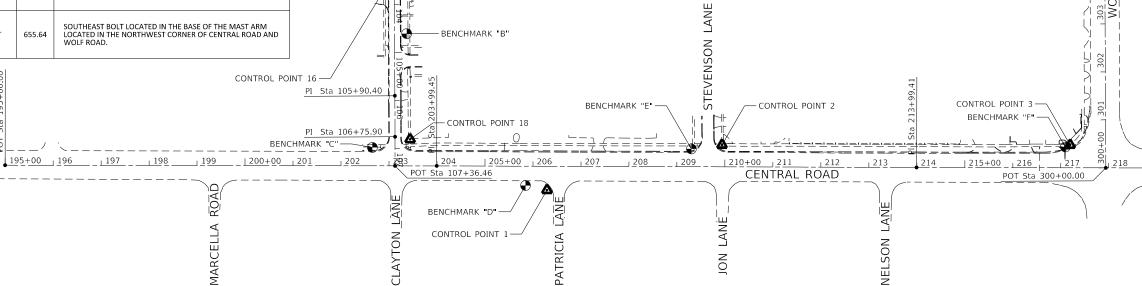

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PLOT DATE = 2/16/2024	DATE	-	2/18/2024	REVISED	-

VILLAGE	0F	MOUNT	PROSPECT	


RTE.	SECTION	COUNTY	TOTAL SHEETS	SHEET NO.					
		COOK	47	8					
		CONTRACT	NO217	82.01					
	ILLINOIS FED. AID PROJECT								


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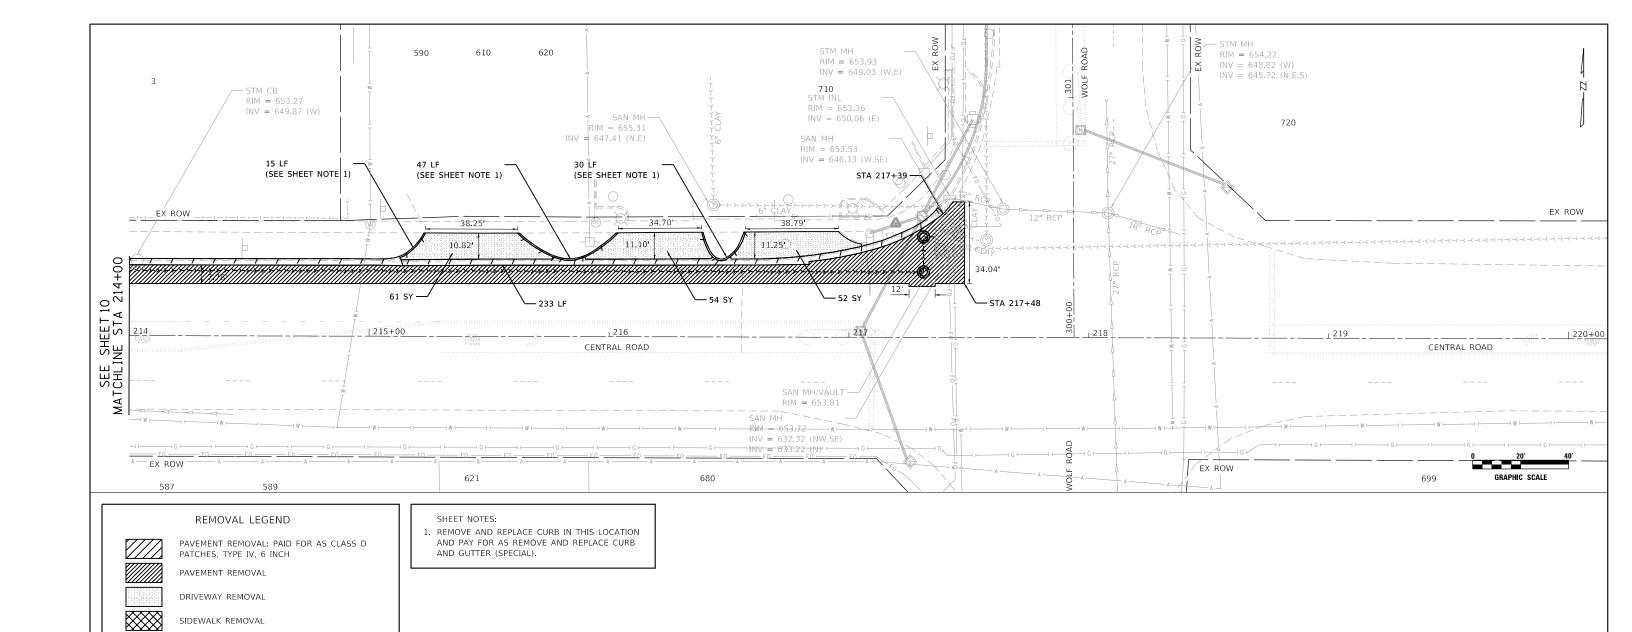
-EX Q CENTRAL ROAD

GRAPHIC SCALE

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ABANDON FORCE MAIN (SEE SHEET NOTE 2)


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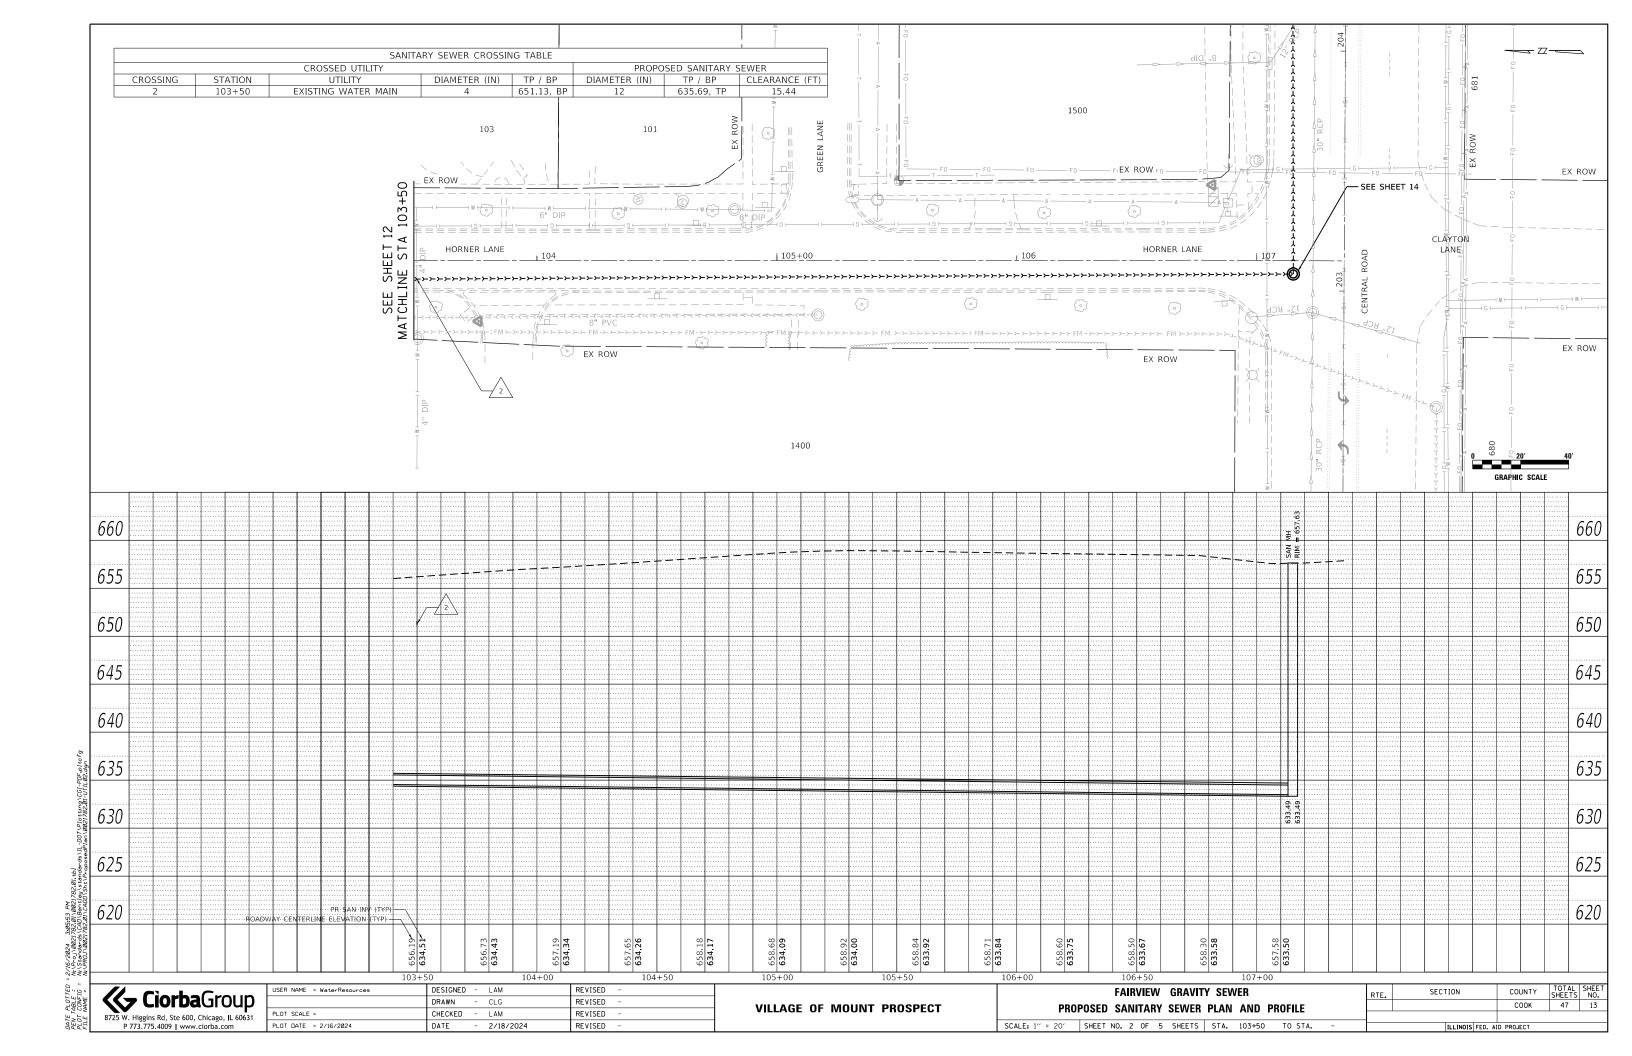
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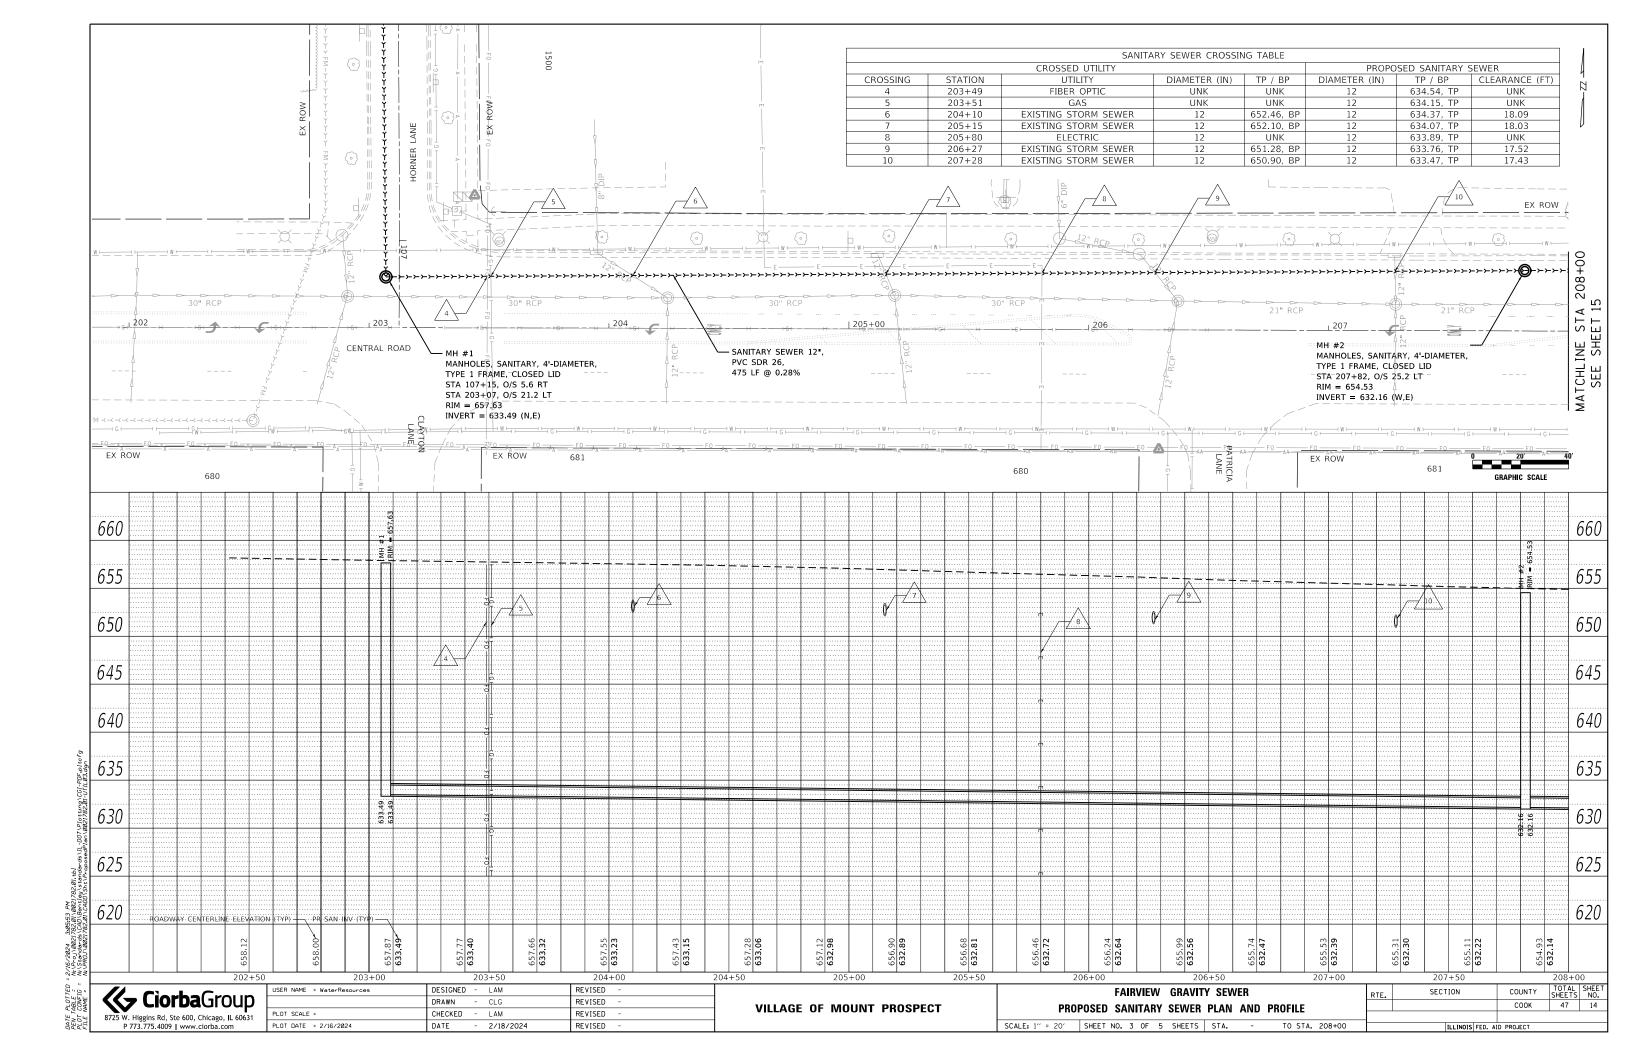
VILLAGE OF MOUNT PROSPECT

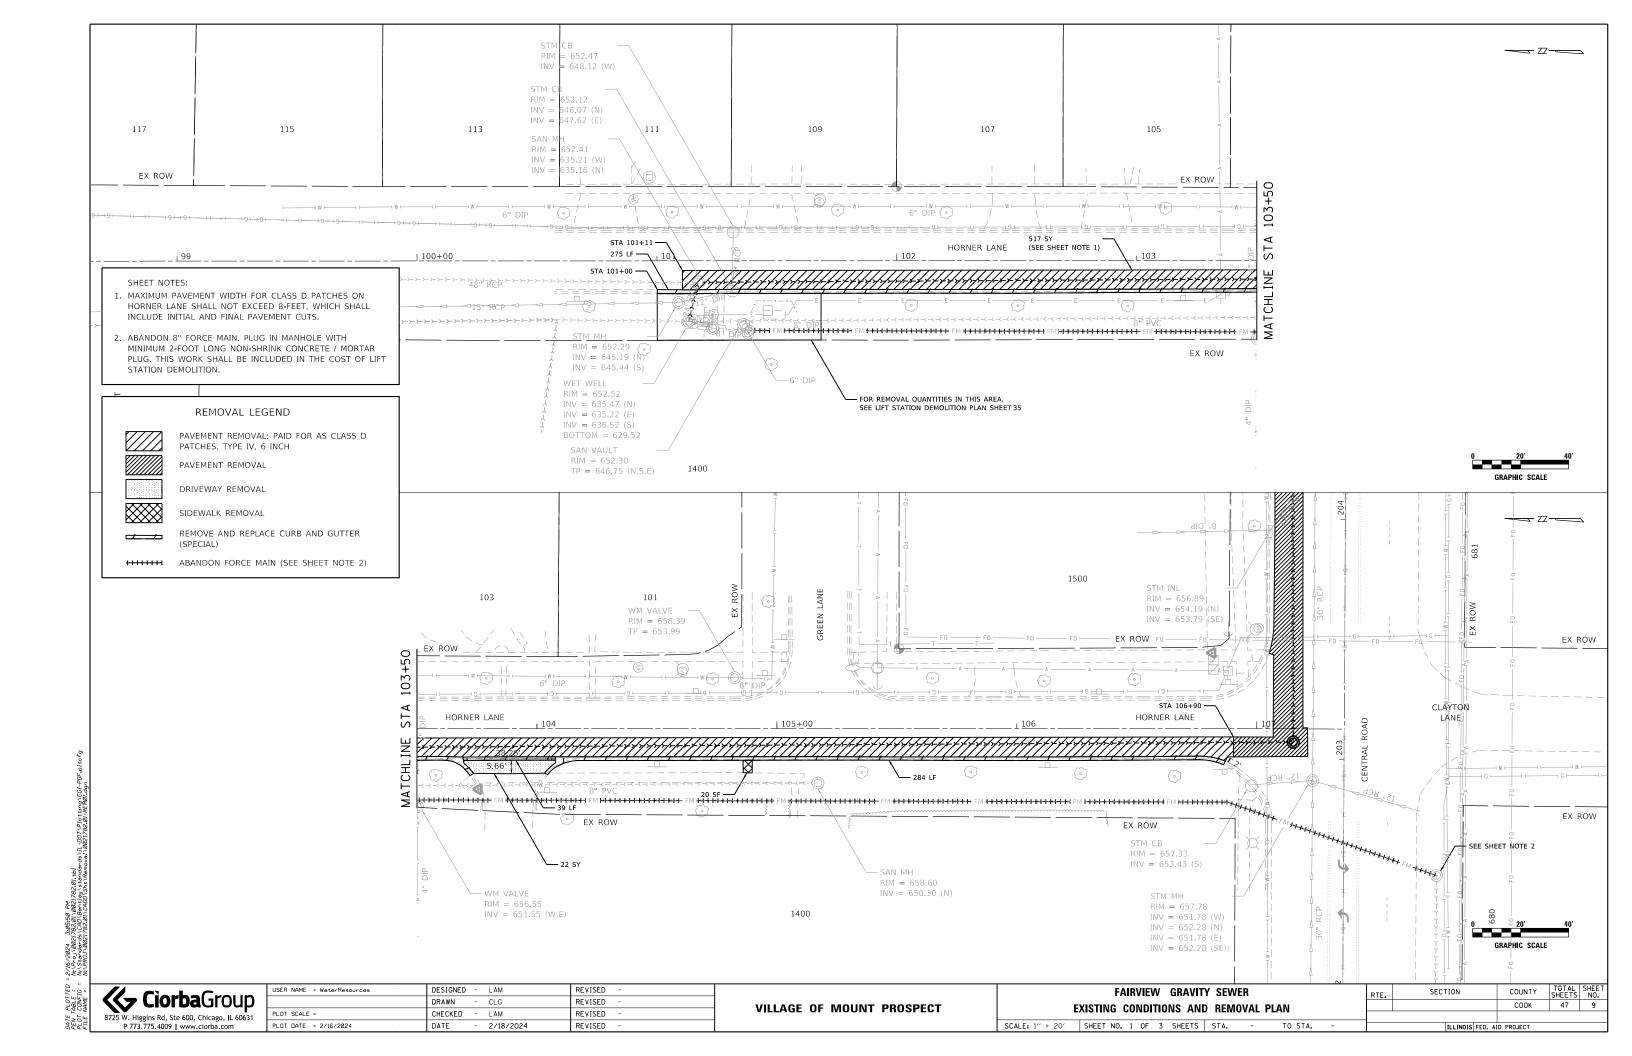
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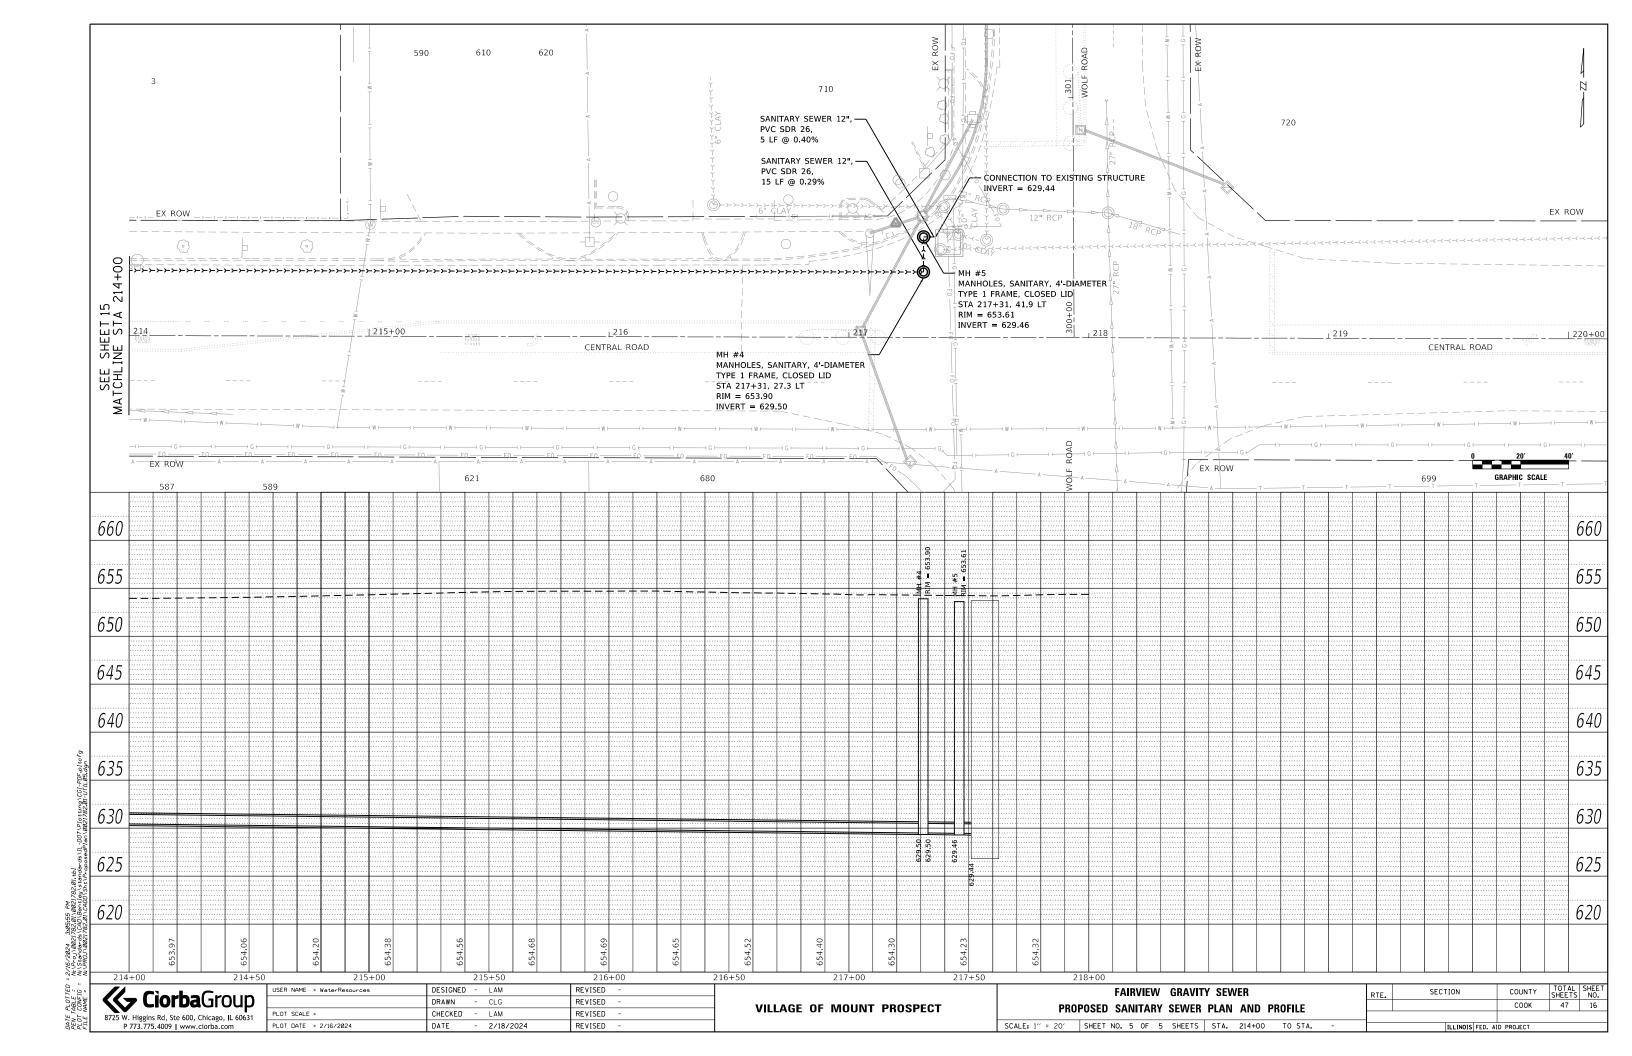
	FAIRVIEW GRAVITY SEWER	RTE.	SECTION	COUNTY	TOTAL SHEETS	SHEET NO.	
F	XISTING CONDITIONS AND REMOVAL PLAN			COOK	47	11	
,	SHEET NO. 3 OF 3 SHEETS STA. 214+00 TO STA		TILINOIS EED AT	n ppn iect			

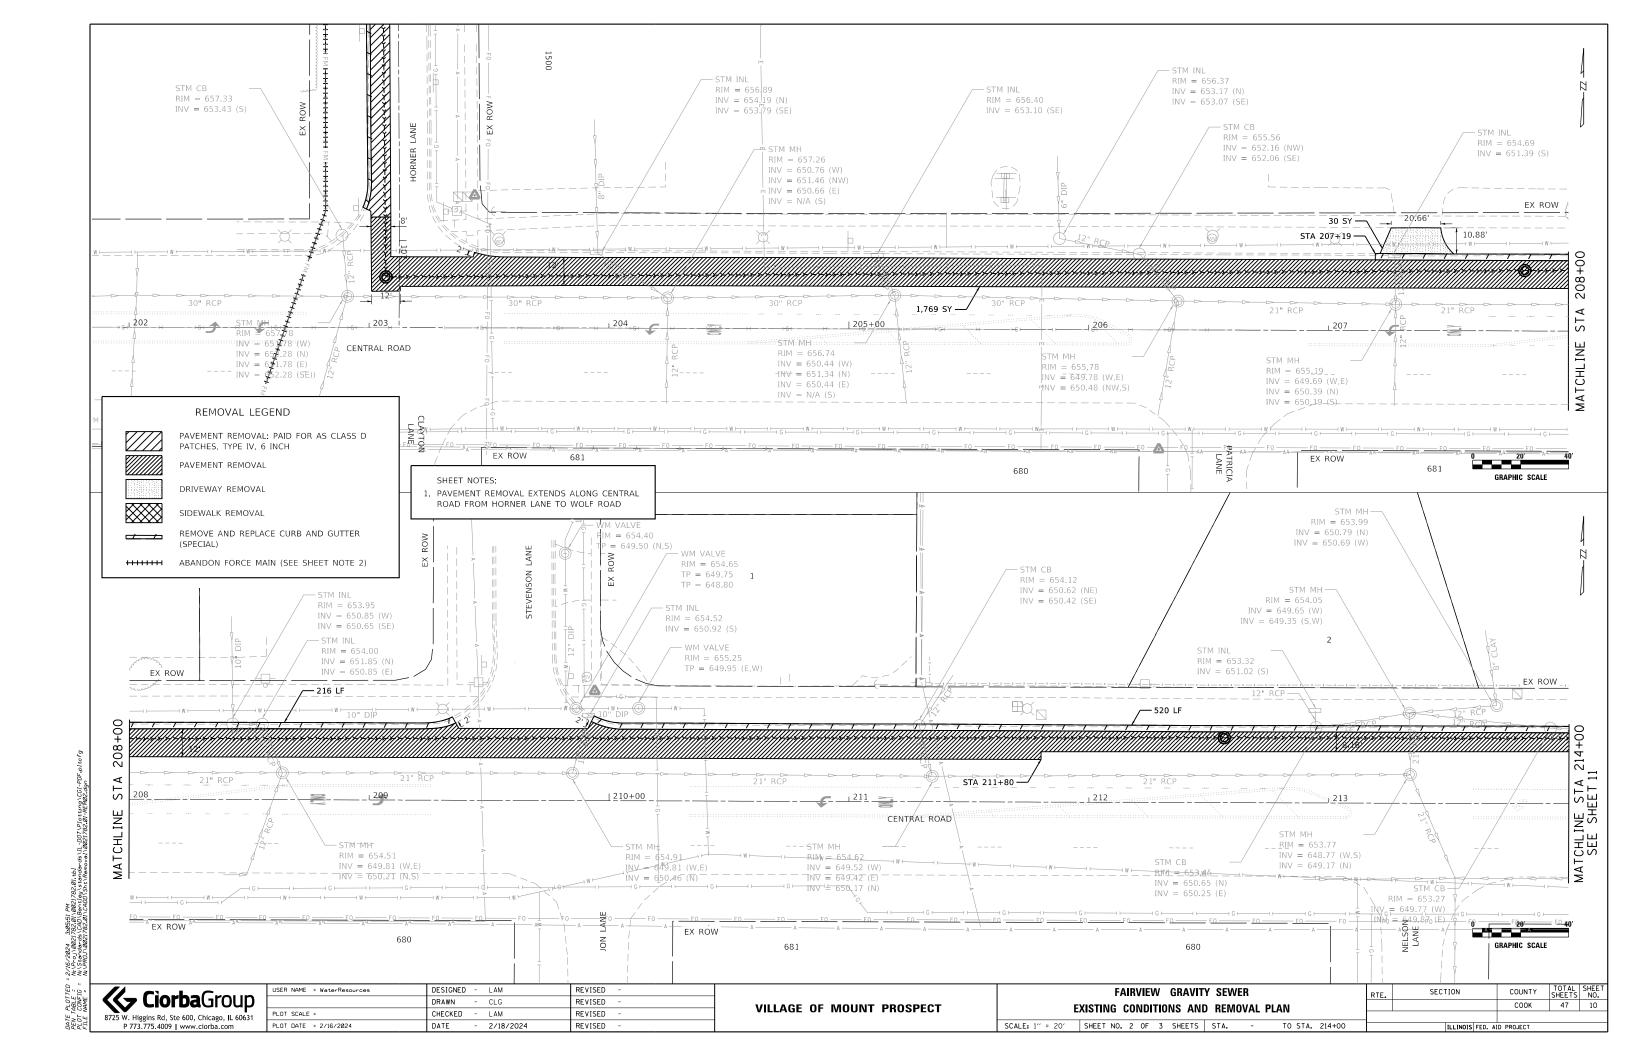





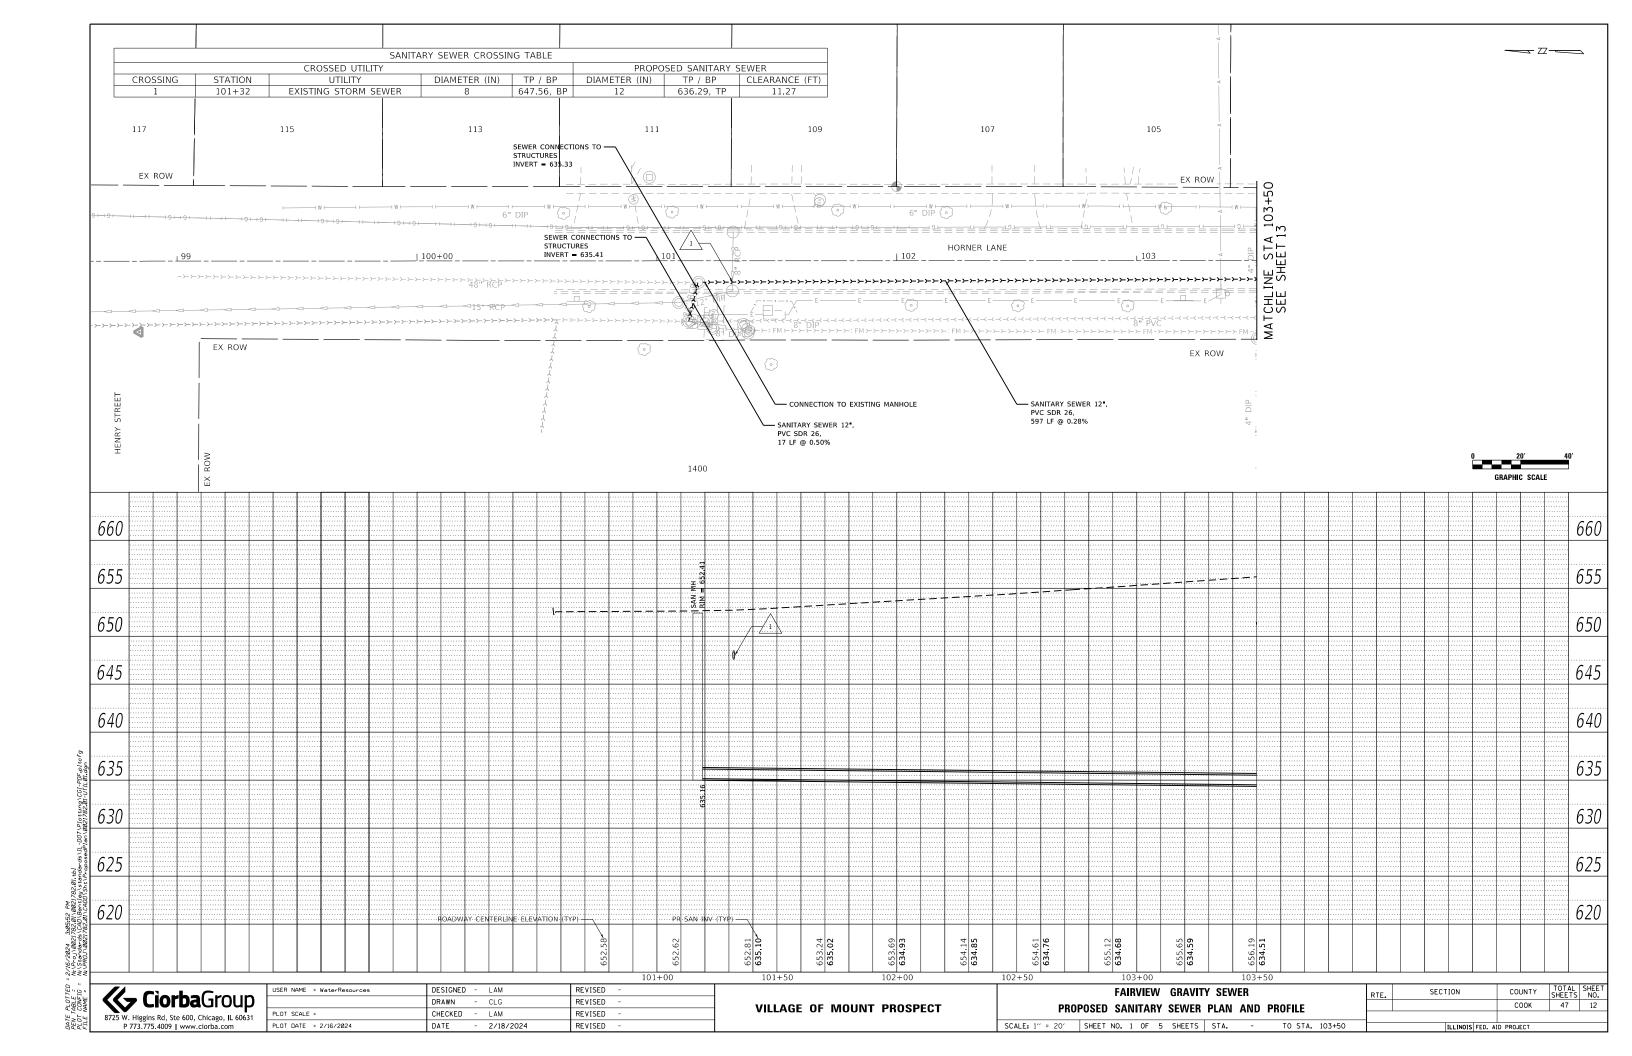

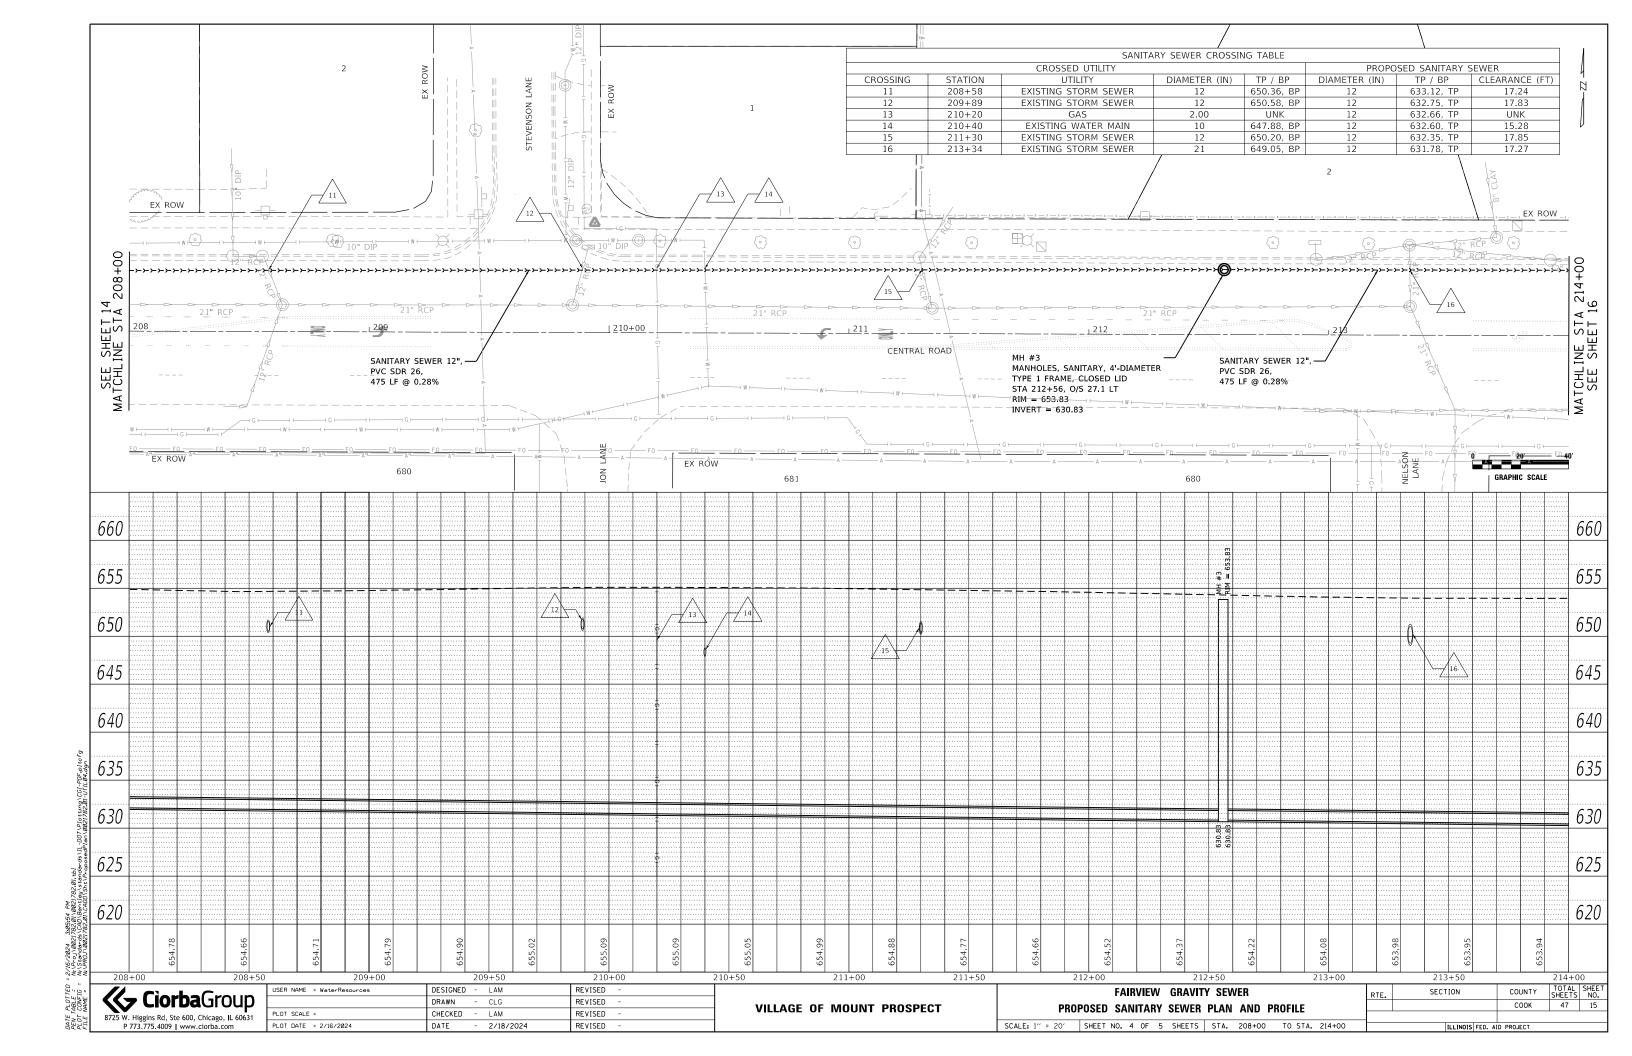

STAGING AND TRAFFIC CONTROL GENERAL NOTES

- 1. STAGING SHALL BE DONE AS SHOWN IN THE PLANS TO MAINTAIN TRAFFIC THROUGHOUT THE AREA.
- THE CONTRACTOR SHALL MAKE NECESSARY PROVISIONS FOR EMERGENCY ACCESS TO ALL STREETS WITHIN THE WORK ZONE. COST WILL BE INCLUDED IN THE TRAFFIC CONTROL ITEMS.
- THE CONTRACTOR SHALL NOTIFY THE ENGINEER 7 CALENDAR DAYS IN ADVANCE OF TRAFFIC CONTROL SWITCHES. THE CONTRACTOR SHALL ALSO CONFIRM WITH THE ENGINEER 24 HOURS IN ADVANCE.
- 4. PRIOR TO REMOVING TRAFFIC CONTROL AND OPENING CLOSED PAVEMENT AREAS TO TRAFFIC THE CONTRACTOR SHALL SWEEP THE PAVEMENT SURFACE CLEAN. THIS WORK WILL NOT BE PAID FOR SEPARATELY BUT SHALL BE INCLUDED IN THE TRAFFIC CONTROL PAY ITEMS.
- 5. THE CONTRACTOR SHALL PROVIDE ACCESS TO ALL ENTRANCES THAT ARE TO REMAIN OPEN WITHIN THE WORK ZONE AS REQUIRED PER THE AGGREGATE SURFACE COURSE FOR TEMPORARY ACCESS (D1) SPECIAL PROVISION.
- THE CONTRACTOR SHALL CONSTRUCT THE PAVEMENT SO THE ENTRANCES CAN MAINTAIN ACCESS AT ALL TIMES DURING CONSTRUCTION. THIS WORK WILL BE INCLUDED IN THE COST OF TRAFFIC CONTROL AND PROTECTION (SPECIAL).
- PAVEMENT, CURB, SIDEWALK, AND DRIVEWAY PAVEMENTS MUST BE COMPLETELY REMOVED FROM THE SITE AT THE END OF EACH WORK DAY. NO REMOVAL ITEMS MAY BE STORED ON SITE.
- DROP-OFFS ADJACENT TO THE TRAVEL LANE SHALL BE KEPT TO A MINIMUM. PROTECTION OF THE DROP-OFF SHALL BE PER IDOT BUREAU OF SAFETY PROGRAMS AND ENGINEERING, POLICY MEMORANDUM 4-21. DROP-OFFS GREATER THAN 12 AT LOCATIONS WHERE THE DROP-OFF IS LOCATED WITHIN 8' OF THE EDGE OF TRAVEL LANE SHALL BE BACKFILLED IN ACCORDANCE WITH TABLE 2 CONDITION II OF THE SAFETY 4-21 POLICY.

STAGING AND TRAFFIC CONTROL GENERAL SEQUENCE OF CONSTRUCTION

CENTRAL ROAD-

CONSTRUCTION

- INSTALL TRAFFIC CONTROL MEASURES AS SHOWN ON THE TRAFFIC CONTROL PLANS.
- MAKE CONNECTION TO EXISTING SANITARY STRUCTURE.
- INSTALL PIPE AND STRUCTURES
- PLACE PCC BASE COURSE AND HMA BINDER COURSE.
- REPLACE CURB AND GUTTER AND REPLACE DRIVEWAYS. COMPLETE RESTORATION AND PAVEMENT MARKINGS.

TRAFFIC CONTROL

- 1. CLOSE OUTSIDE WESTBOUND LANE AS SHOWN ON THE TRAFFIC CONTROL PLANS.
- INSTALL TEMPORARY CONCRETE BARRIER AND ATTENUATOR AS SHOWN ON THE TRAFFIC CONTROL PLANS.
- SHIFT WESTBOUND TRAFFIC AS SHOWN IN THE TRAFFIC CONTROL PLANS AND PER HIGHWAY STANDARD

HORNER LANE-

CONSTRUCTION

- INSTALL TRAFFIC CONTROL MEASURES AS SHOWN ON THE TRAFFIC CONTROL PLANS.
- INSTALL PIPE AND STRUCTURES.
- MAKE CONNECTION TO EXISITNG SANITARY STRUCTURE.

SCALE:

- PATCH PAVEMENT.
- REPLACE CURB AND GUTTER.
- COMPLETE RESTORATION.

TRAFFIC CONTROL

1. TRAFFIC SHALL BE CONTROLLED WITH THE PLACEMENT OF TYPE III BARRICADES WITHIN THE LIMITS OF THE WORK INCLUDING "ROAD CLOSED TO THROUGH TRAFFIC" SIGNAGE. TYPE III TRAFFIC SIGNAGE SHALL BE REMOVED AT THE END OF EACH WORKING DAY. LOCAL TRAFFIC THROUGH THE WORK ZONE SHALL BE MAINTAINED USING FLAGGERS DURING WORKING HOURS. THE CONTRACTOR SHALL COORDINATE WORK SO THAT THE ROADWAY CAN BE OPENED TO THE TWO-WAY TRAFFIC AT THE END OF EACH DAY. AT A MINIMUM THE CONTRACTOR SHALL PROVIDE AN AGGREGATE SURFACE AS SHOWN IN THE TRENCH SECTION DETAIL.


WOLF ROAD-

TRAFFIC CONTROL

1. CLOSE OUTSIDE SOUTHBOUND LANE AS SHOWN ON THE TRAFFIC CONTROL PLANS AND PER HIGHWAY STANDARD 701606.

USER NAME = WaterResources	DESIGNED -	EPS	REVISED -	
	DRAWN -	AS	REVISED -	
PLOT SCALE = 20.0000 '/ in.	CHECKED -	EPS	REVISED -	
PLOT DATE = 2/16/2024	DATE -	2/18/2024	REVISED -	

	FAIRVIEW GRAVITY SEWER						SECTION	COUNTY	TOTAL SHEETS	SHEE NO.
v	ΙΔΙΝΤΕΝΔΝ	ICE OF	TRAFFIC	GENERAL	NOTES			COOK	47	17
•	IAINTENANCE OF TRAFFIC GENERAL NOTES				CONTRACT	NO217	82.01			
ı	SHEET NO.	OF	SHEETS	STA.	TO STA.		ILLINOIS FED. A	D PROJECT		

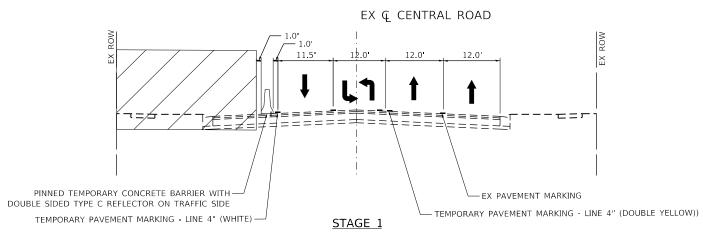


STA 212+00.00 TO STA 218+00.41


WORK ZONE


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Ciorba Group	ļ
8725 W. Higgins Rd, Ste 600, Chicago, IL 60631	
P 773.775.4009 www.ciorba.com	


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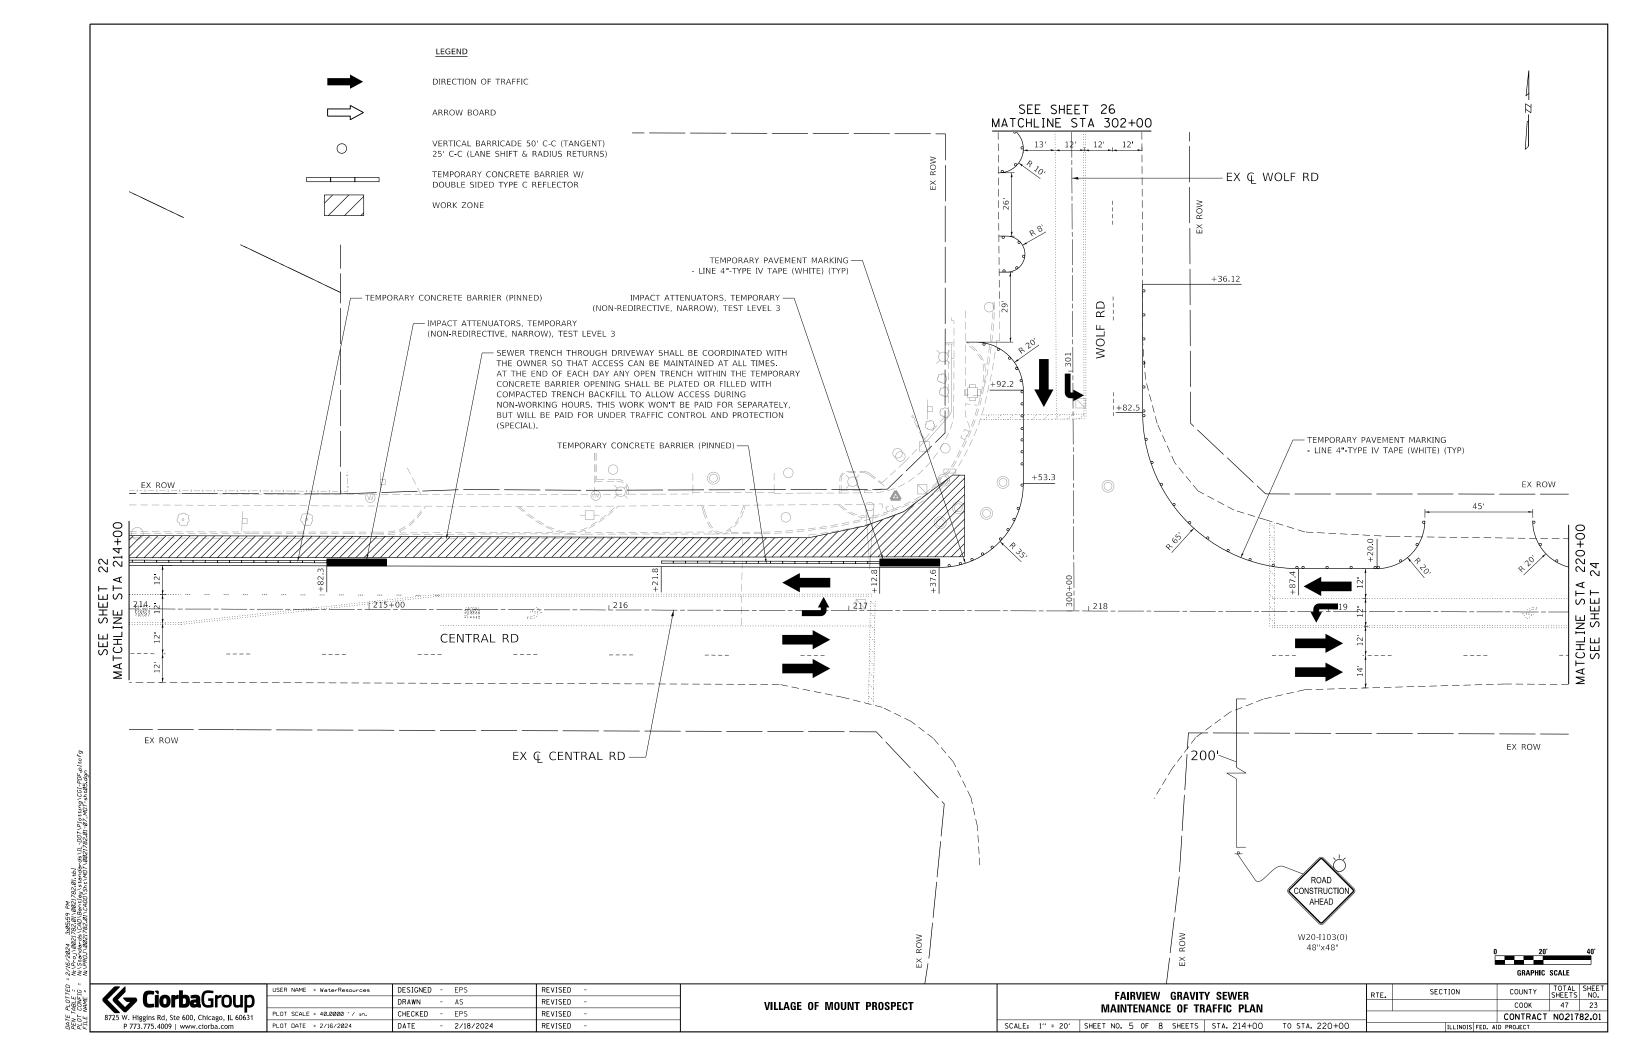
SCALE:




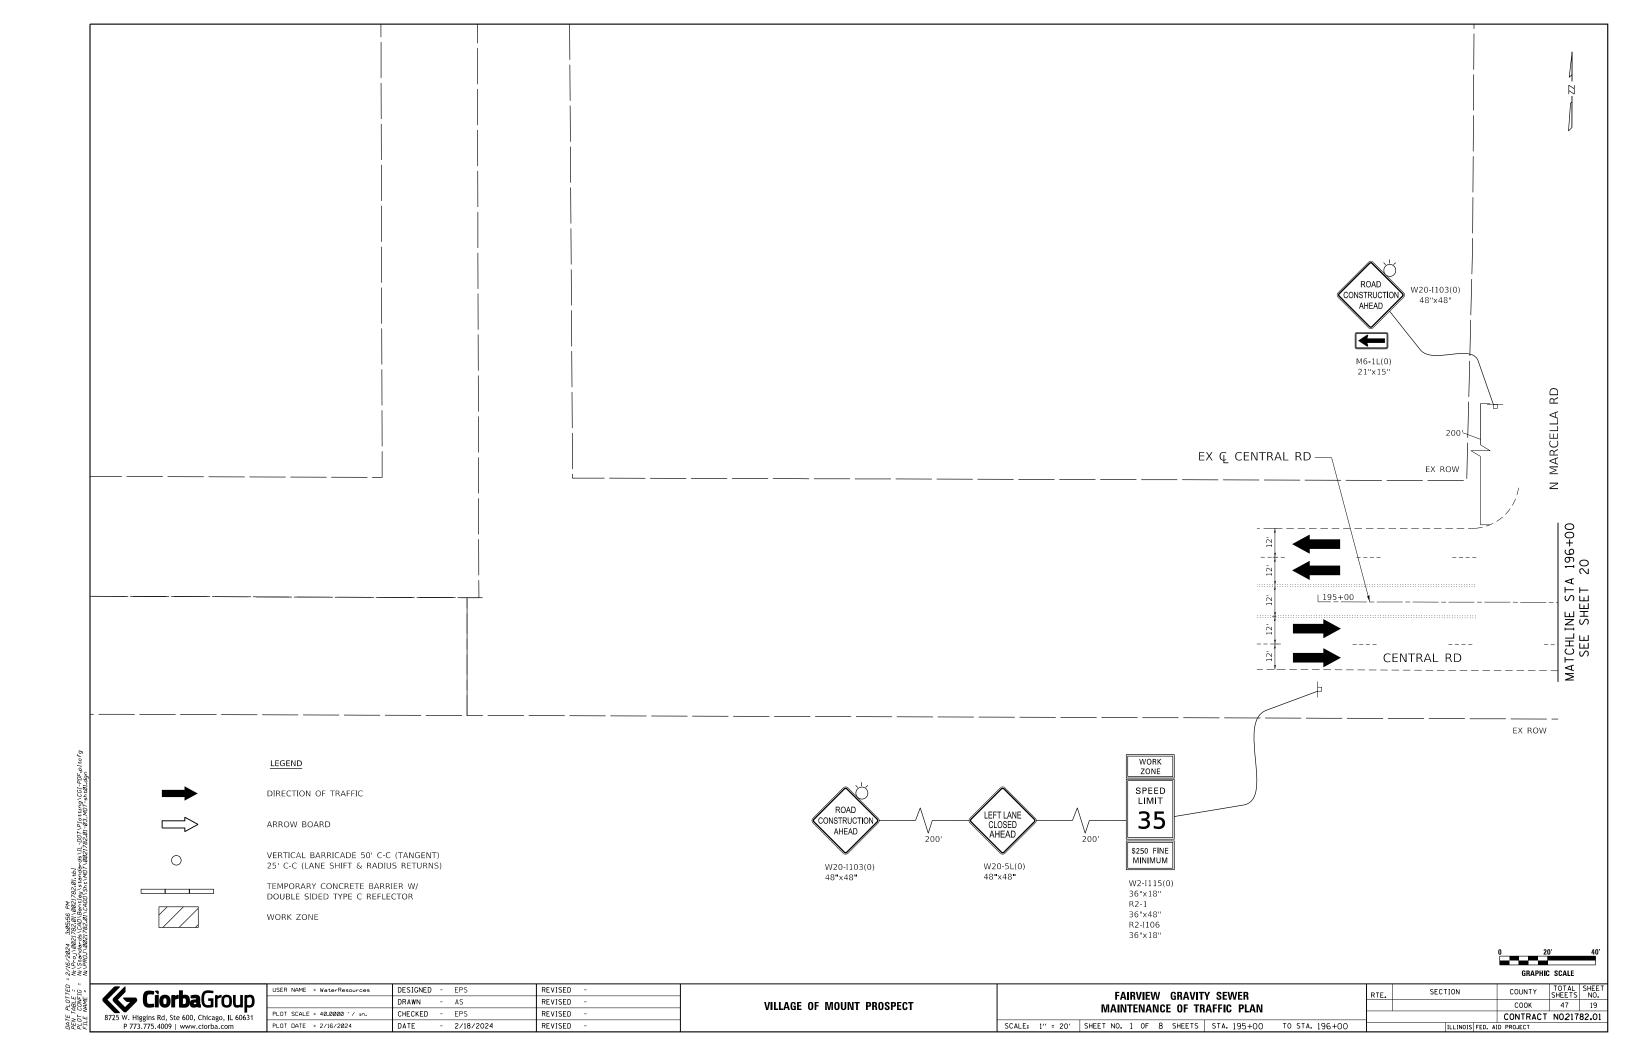


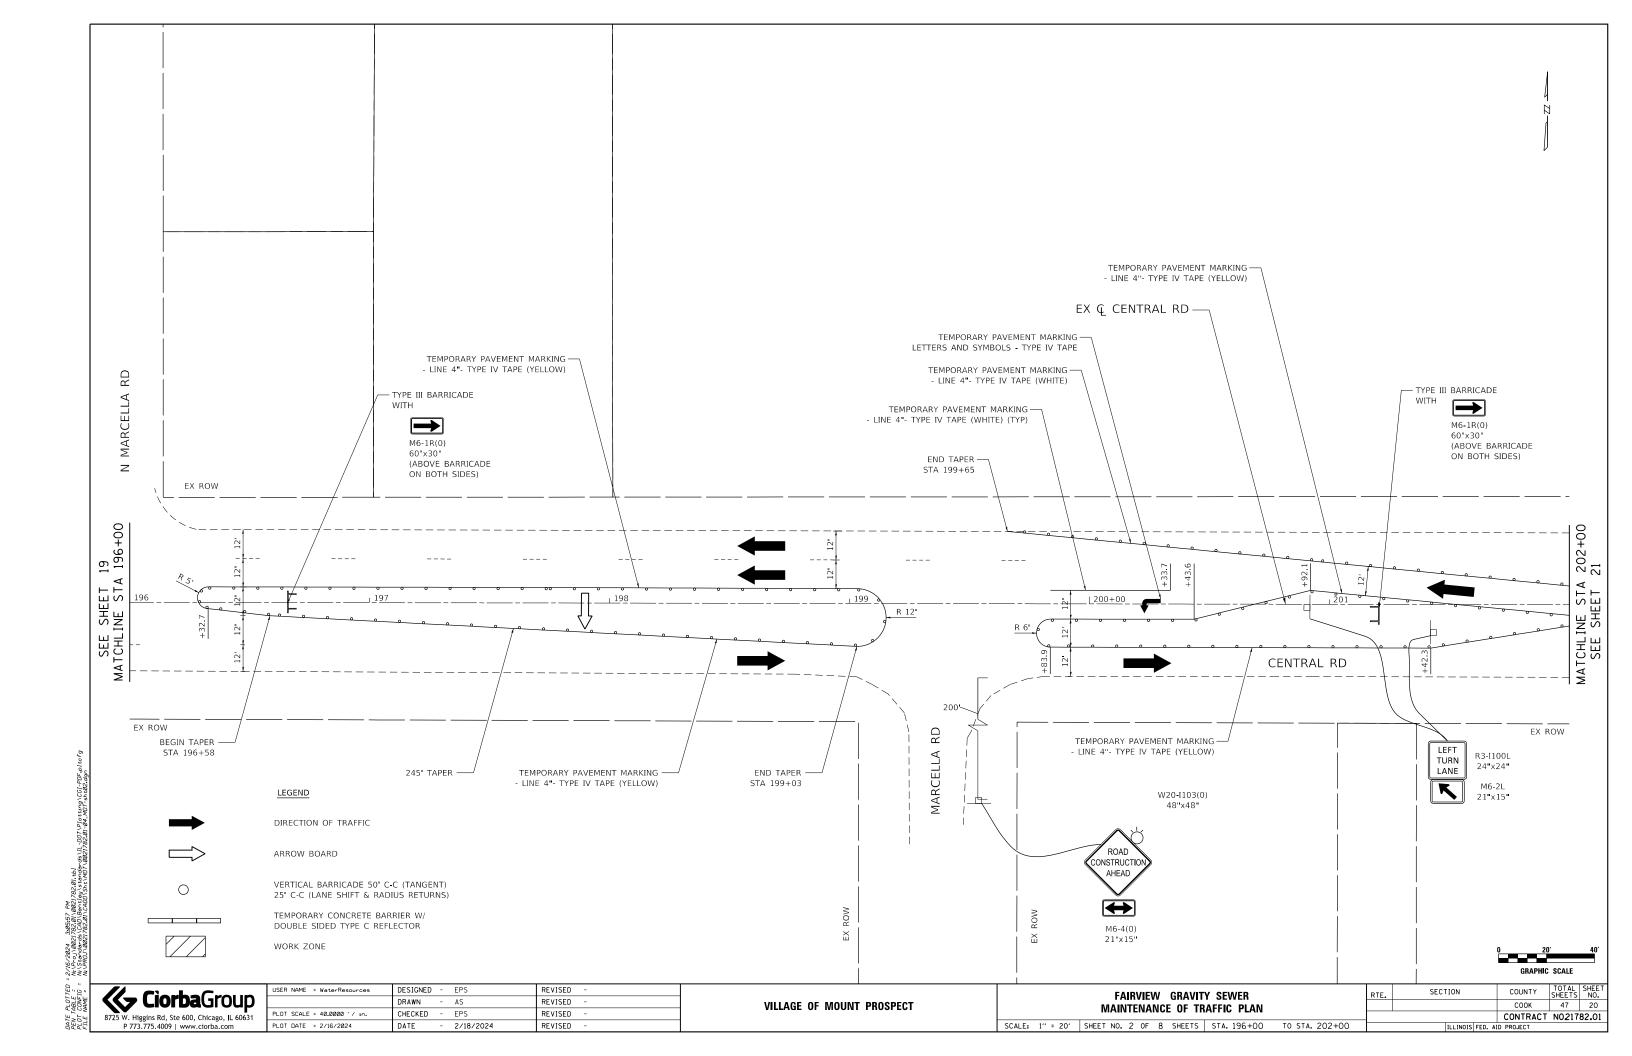

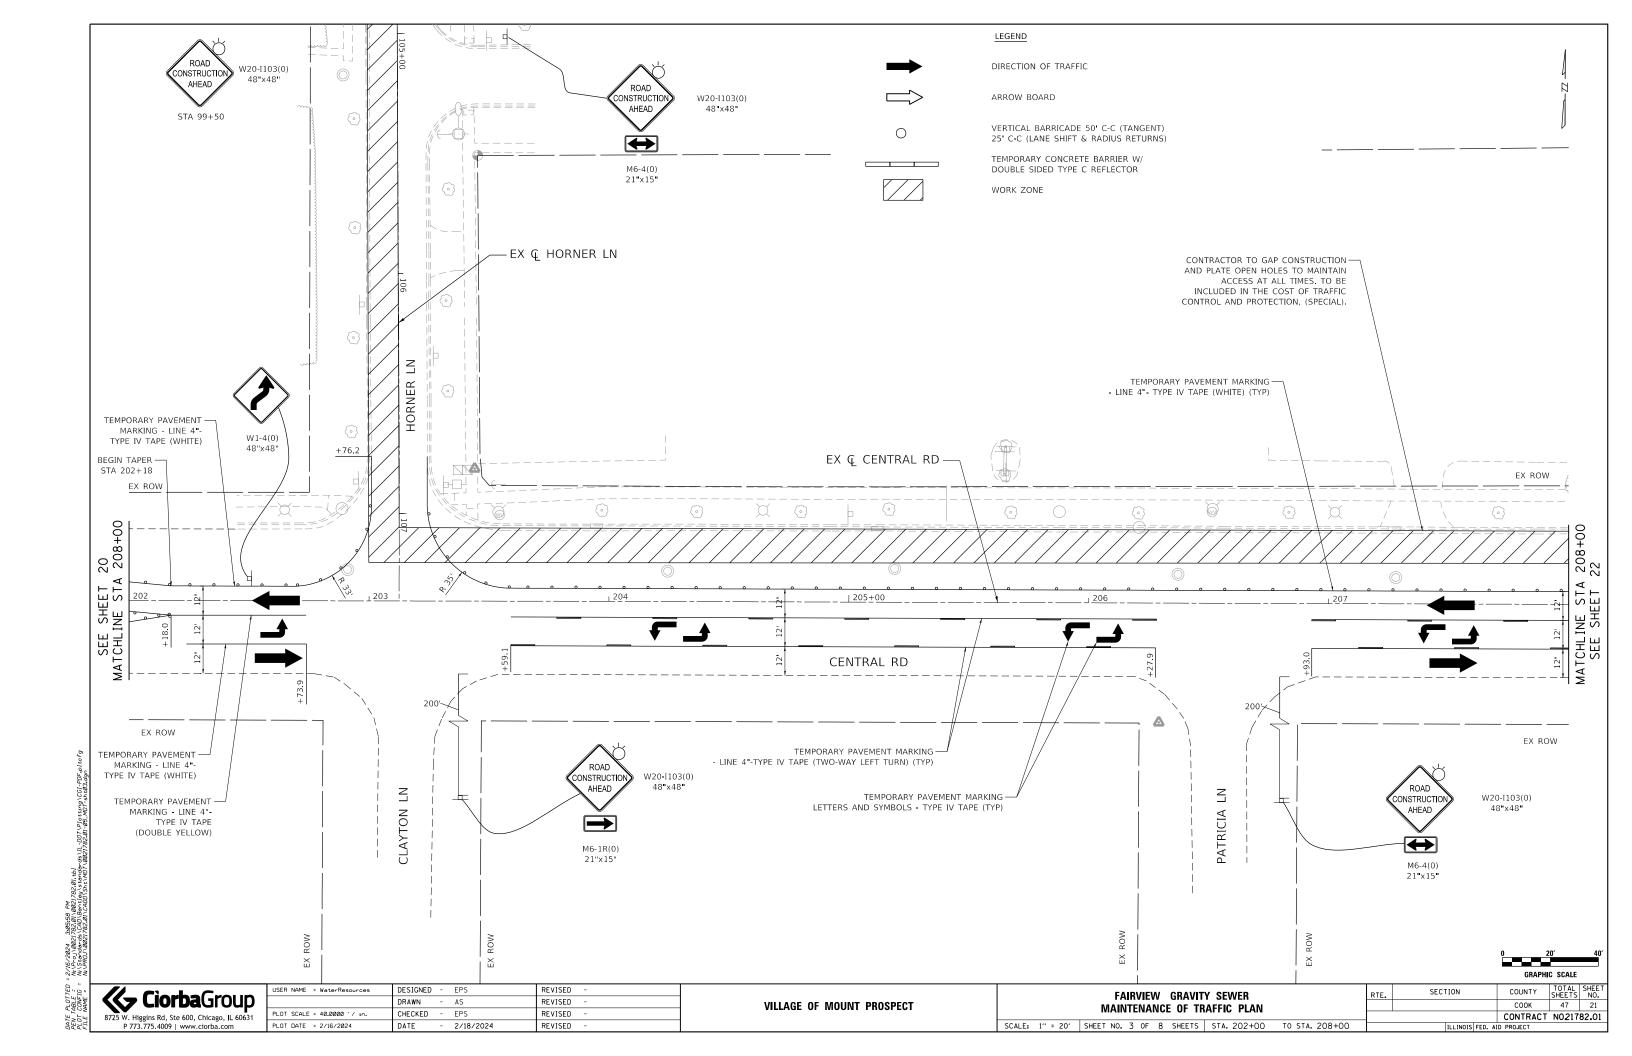

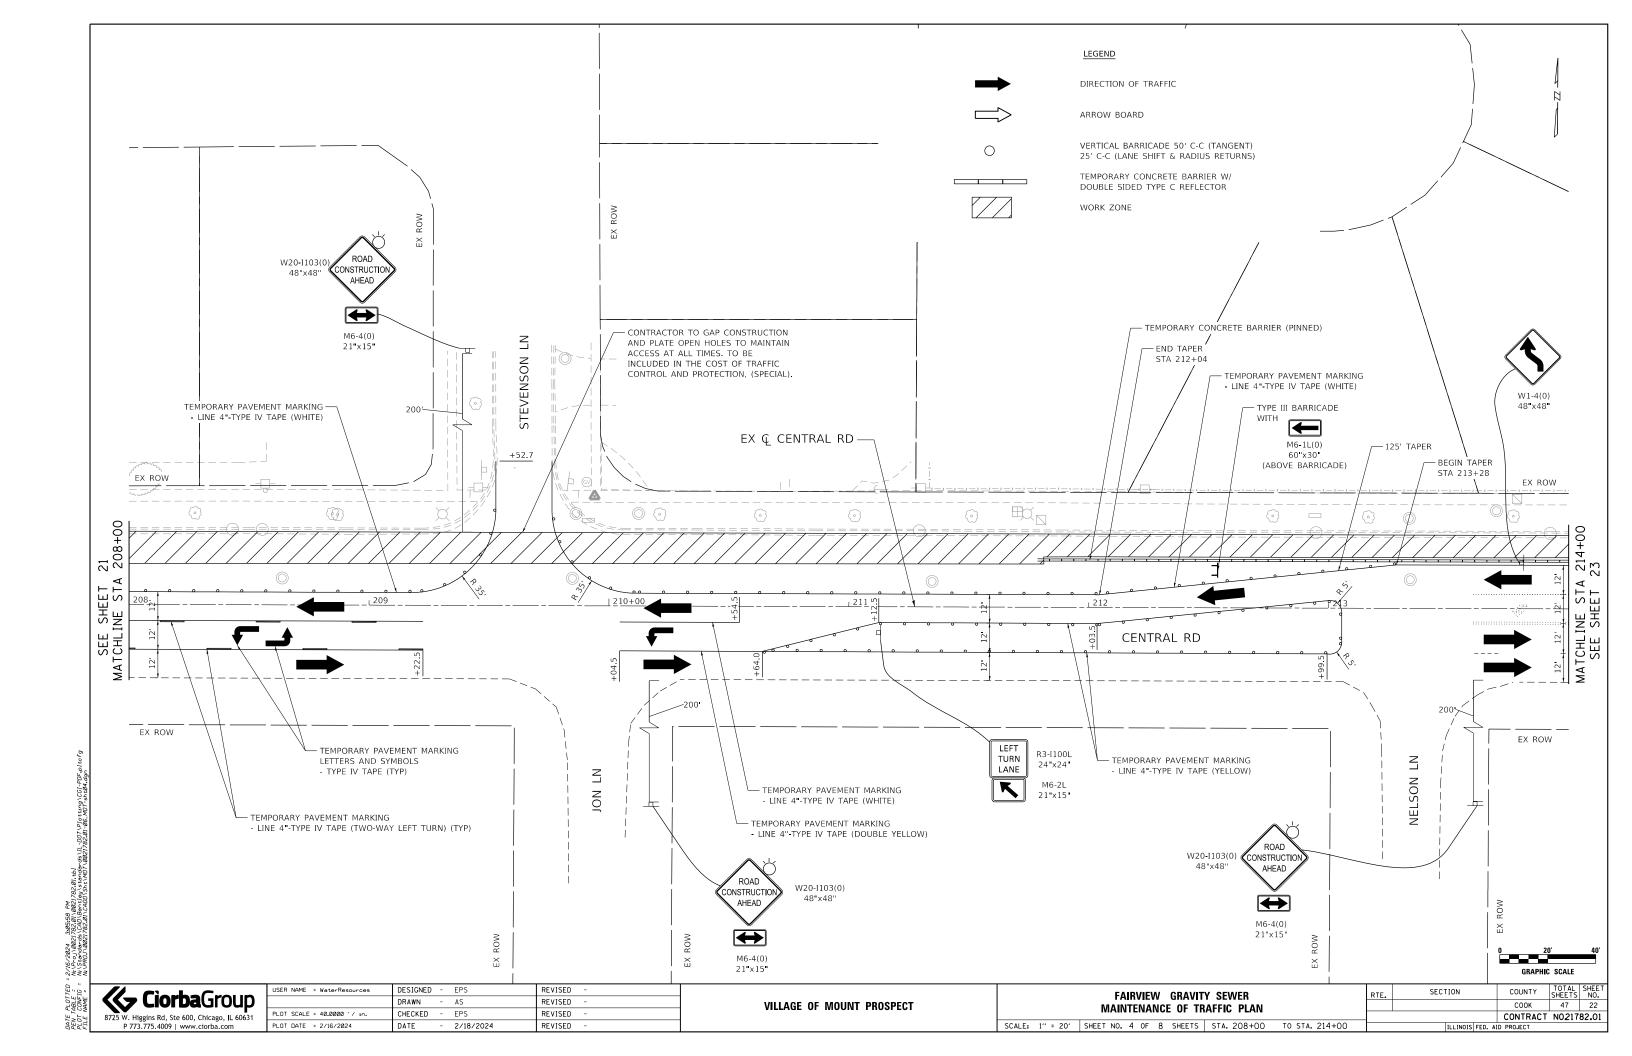

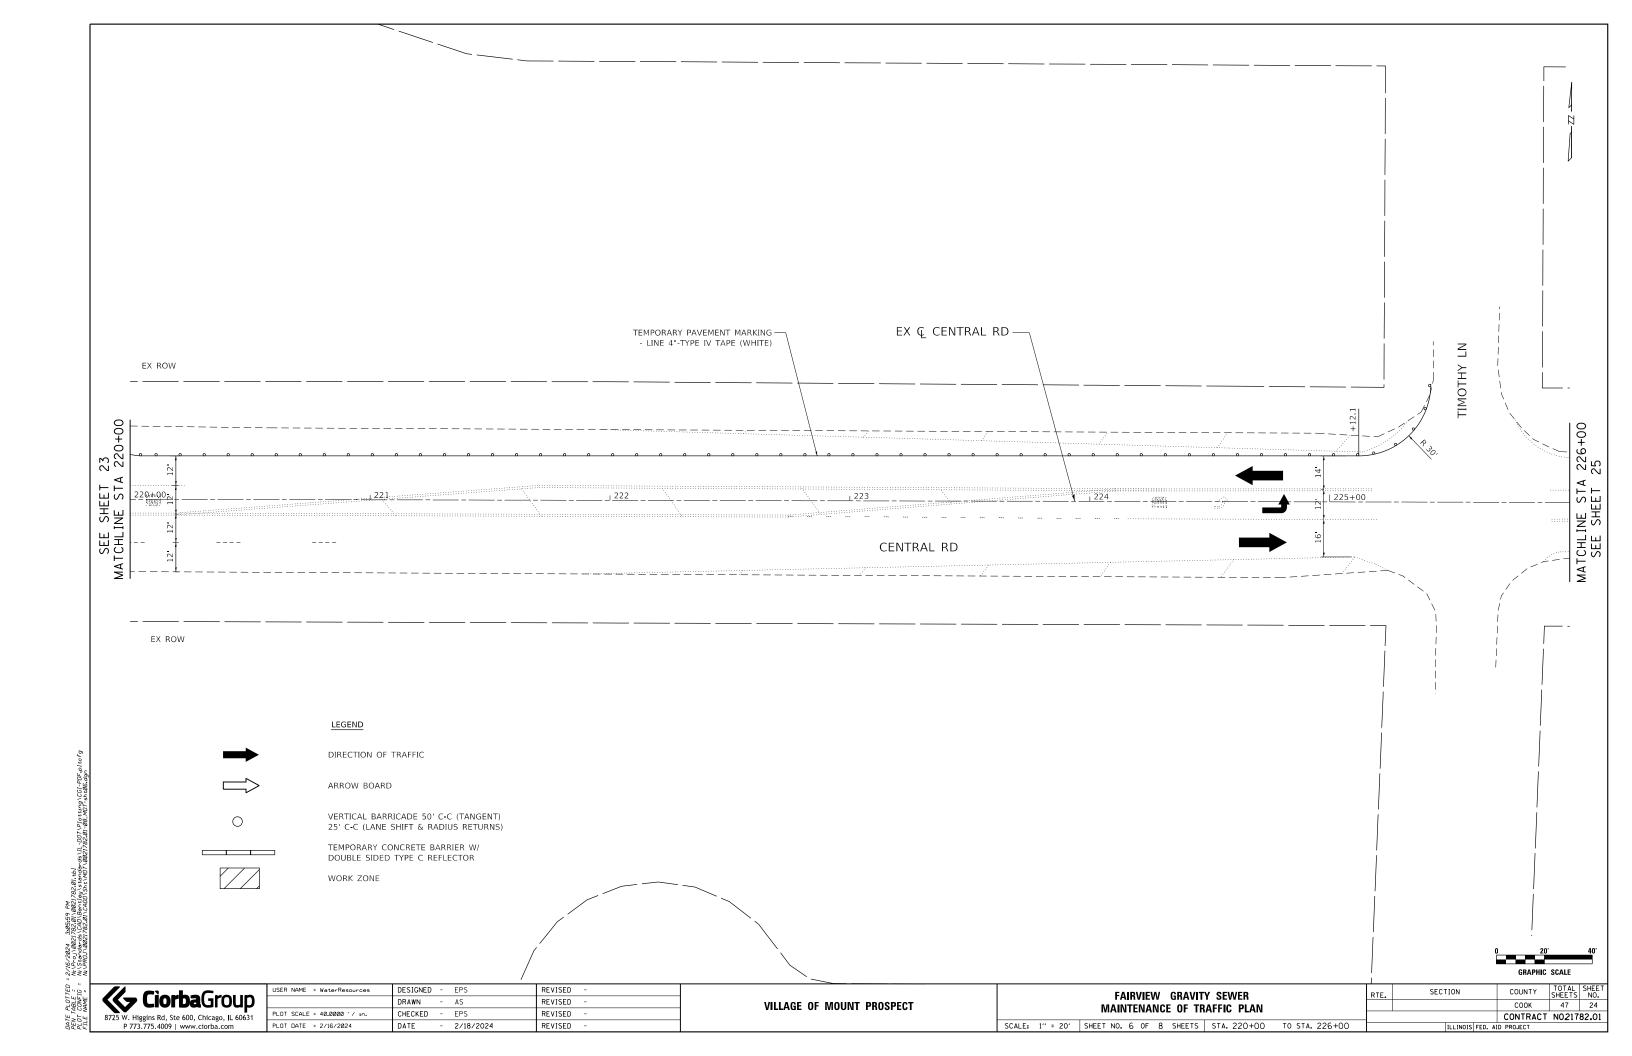

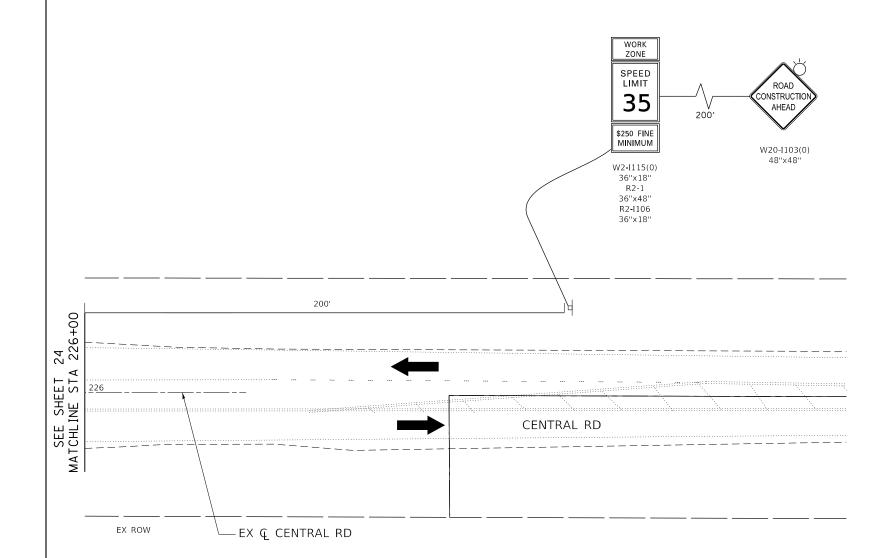

LEGEND

DIRECTION OF TRAFFIC



ARROW BOARD



VERTICAL BARRICADE 50' C-C (TANGENT) 25' C-C (LANE SHIFT & RADIUS RETURNS)

TEMPORARY CONCRETE BARRIER W/ DOUBLE SIDED TYPE C REFLECTOR

WORK ZONE

GRAPHIC SCALE




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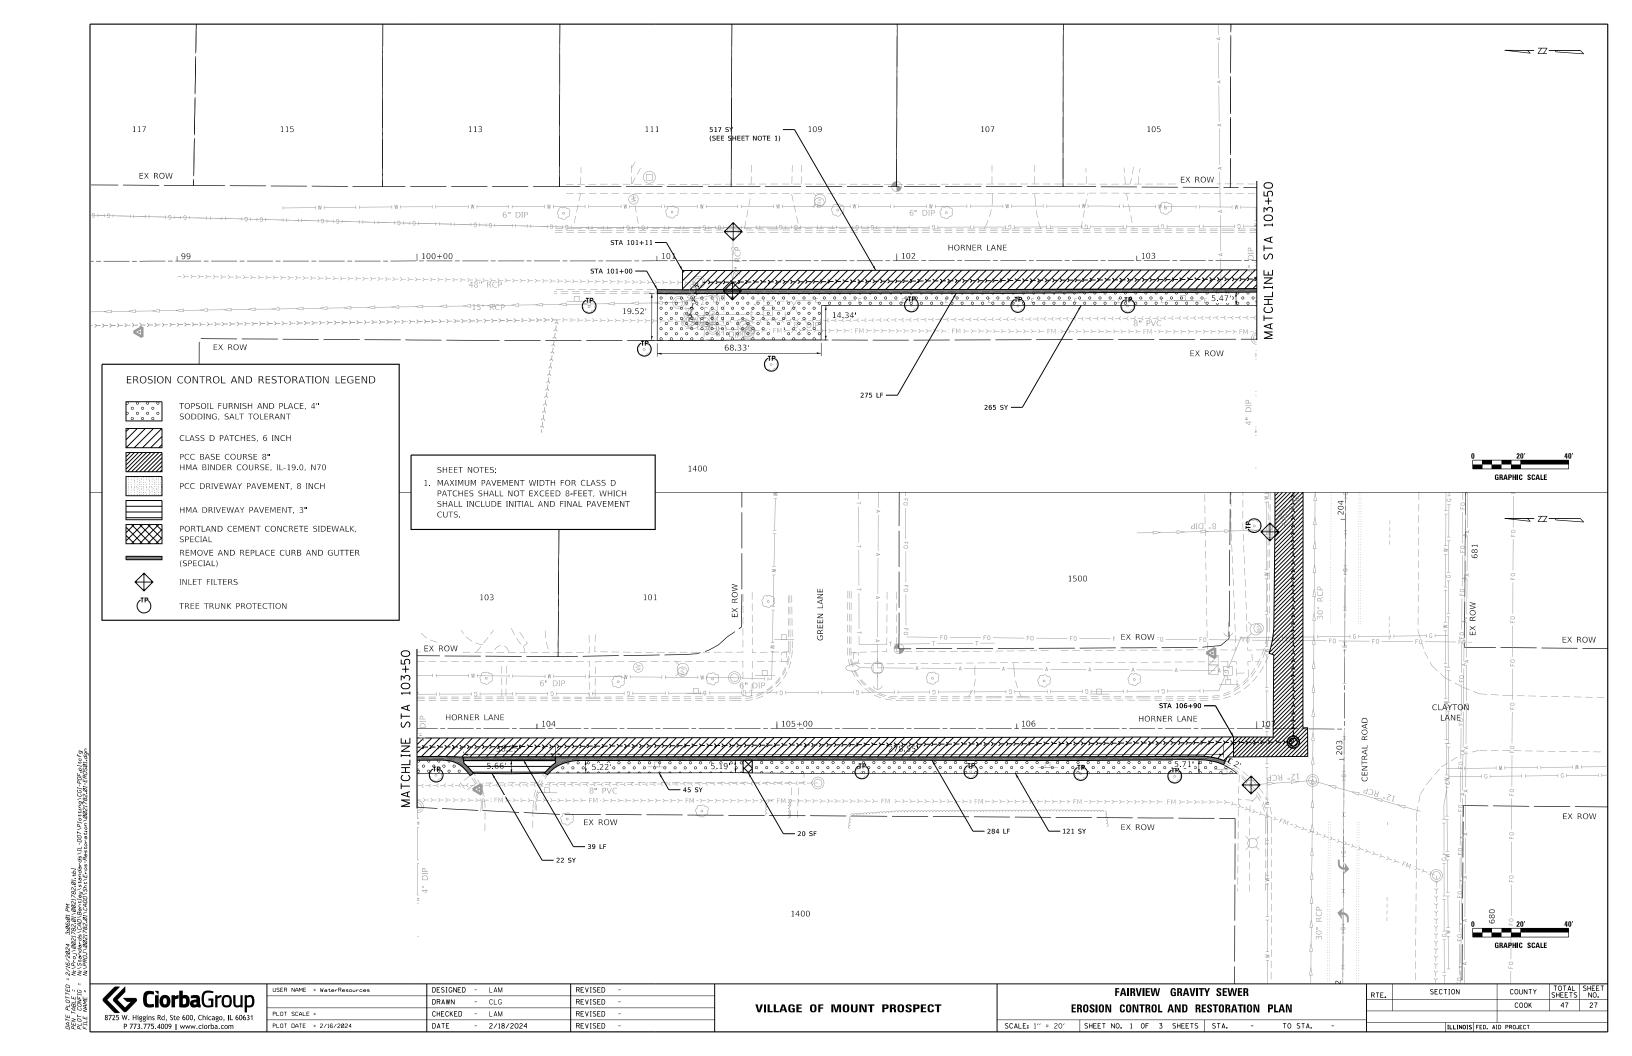
FAIRVIEW GRAVITY SEWER MAINTENANCE OF TRAFFIC PLAN								
SCALE:	1" = 20"	SHEET NO.	7	OF	8	SHEETS	STA. 226+00	TO STA. 226+67


VILLAGE OF MOUNT PROSPECT


FAIRVIEW	GRA	VITY	SEW	/ER
MAINTENANCI	OF.	TRA	FFIC	PLA

	TILLINOIS FED. AT	D PROJECT		
		CONTRACT	NO217	82.0
		COOK	47	25
RTE.	SECTION	COUNTY	TOTAL SHEETS	SHE



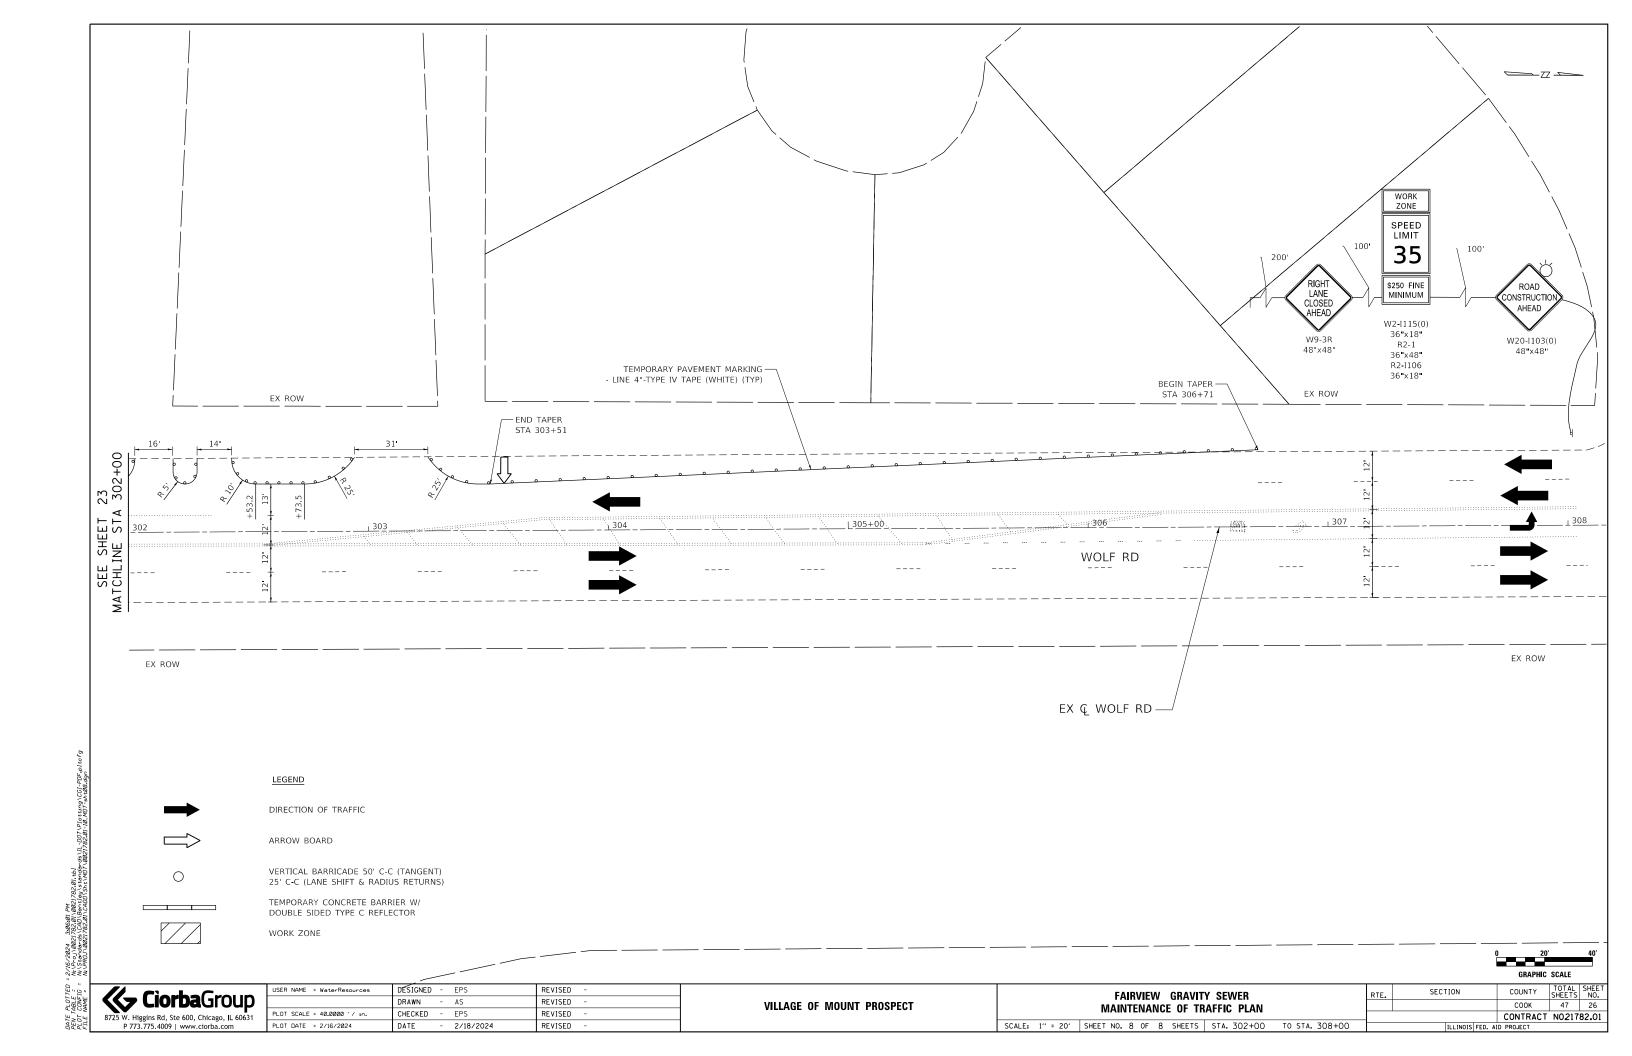

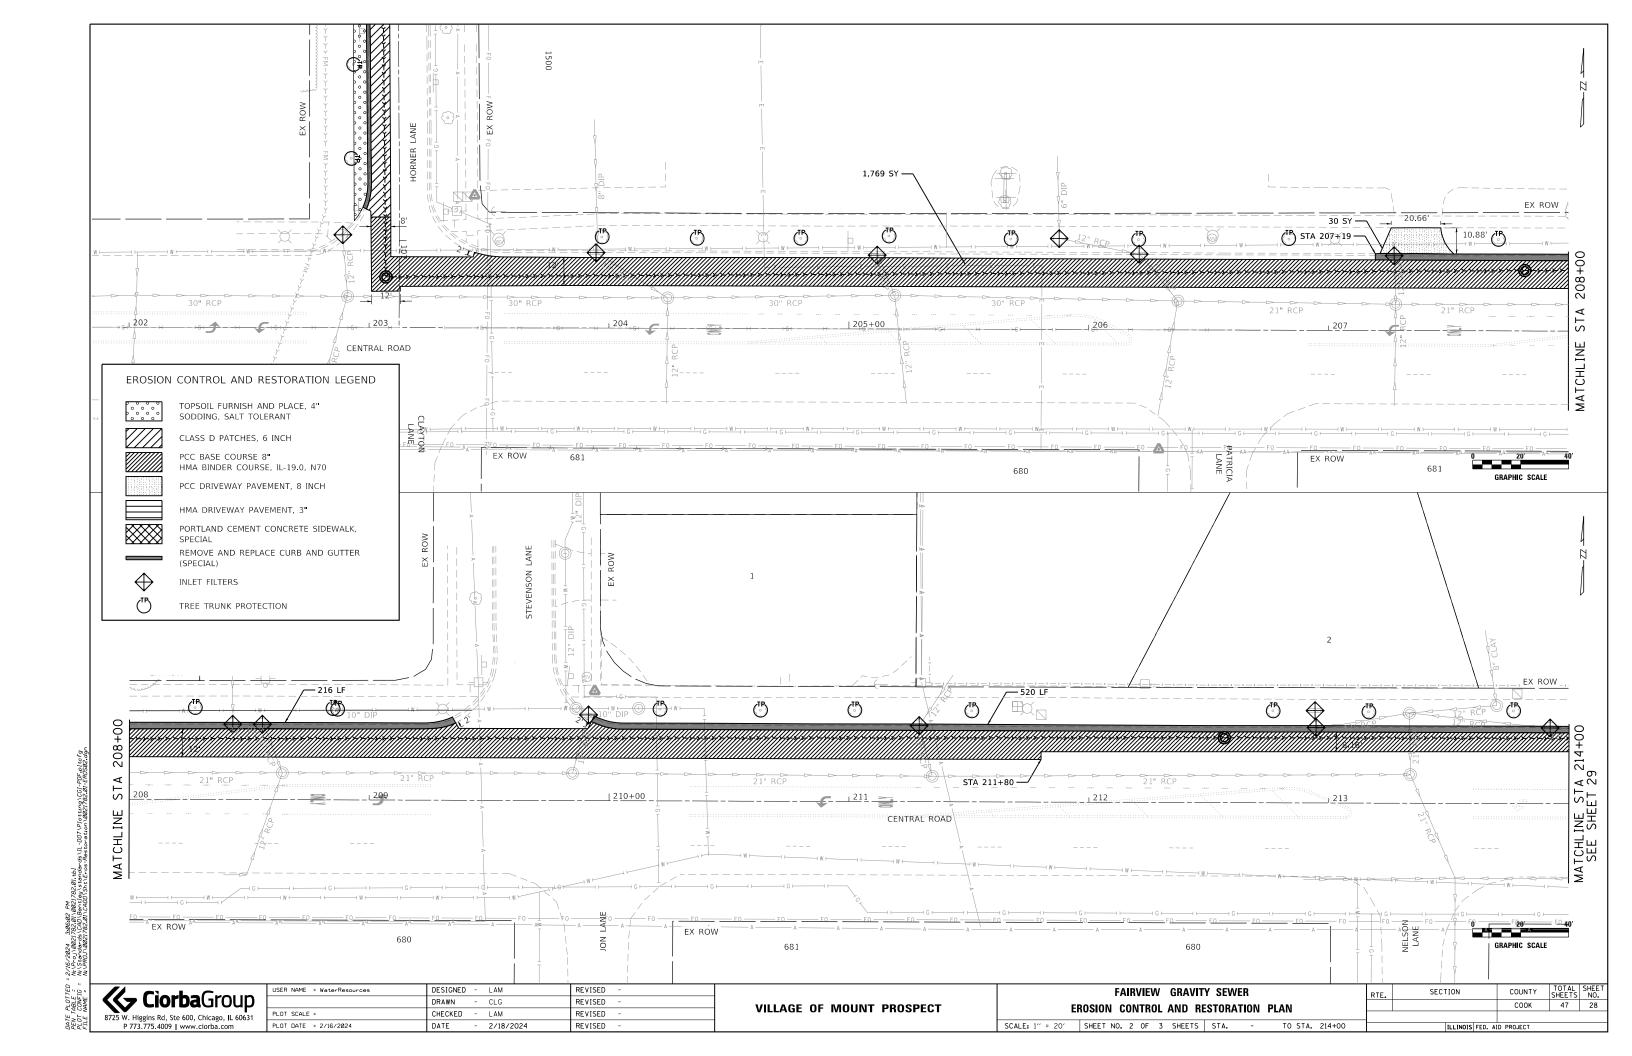

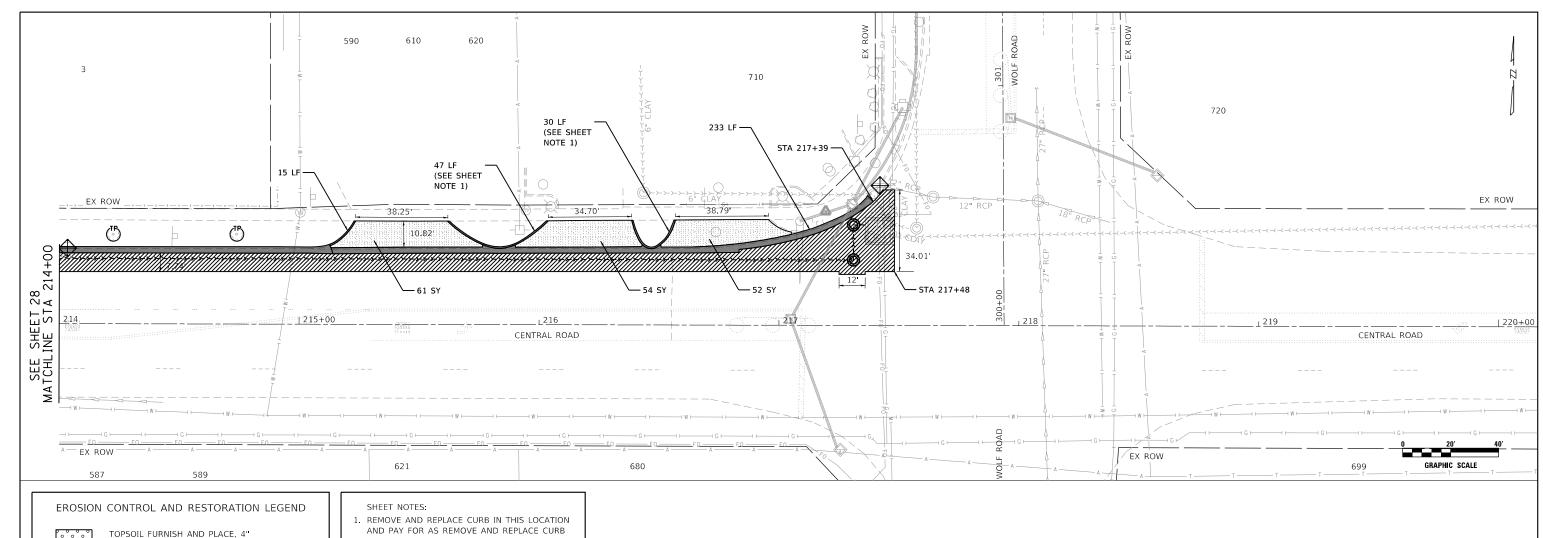

SODDING, SALT TOLERANT

CLASS D PATCHES, 6 INCH

PCC BASE COURSE 8" HMA BINDER COURSE, IL-19.0, N70

PCC DRIVEWAY PAVEMENT, 8 INCH

HMA DRIVEWAY PAVEMENT, 3"

PORTLAND CEMENT CONCRETE SIDEWALK,

REMOVE AND REPLACE CURB AND GUTTER (SPECIAL)

INLET FILTERS

TREE TRUNK PROTECTION

AND PAY FOR AS REMOVE AND REPLACE CURB AND GUTTER (SPECIAL).

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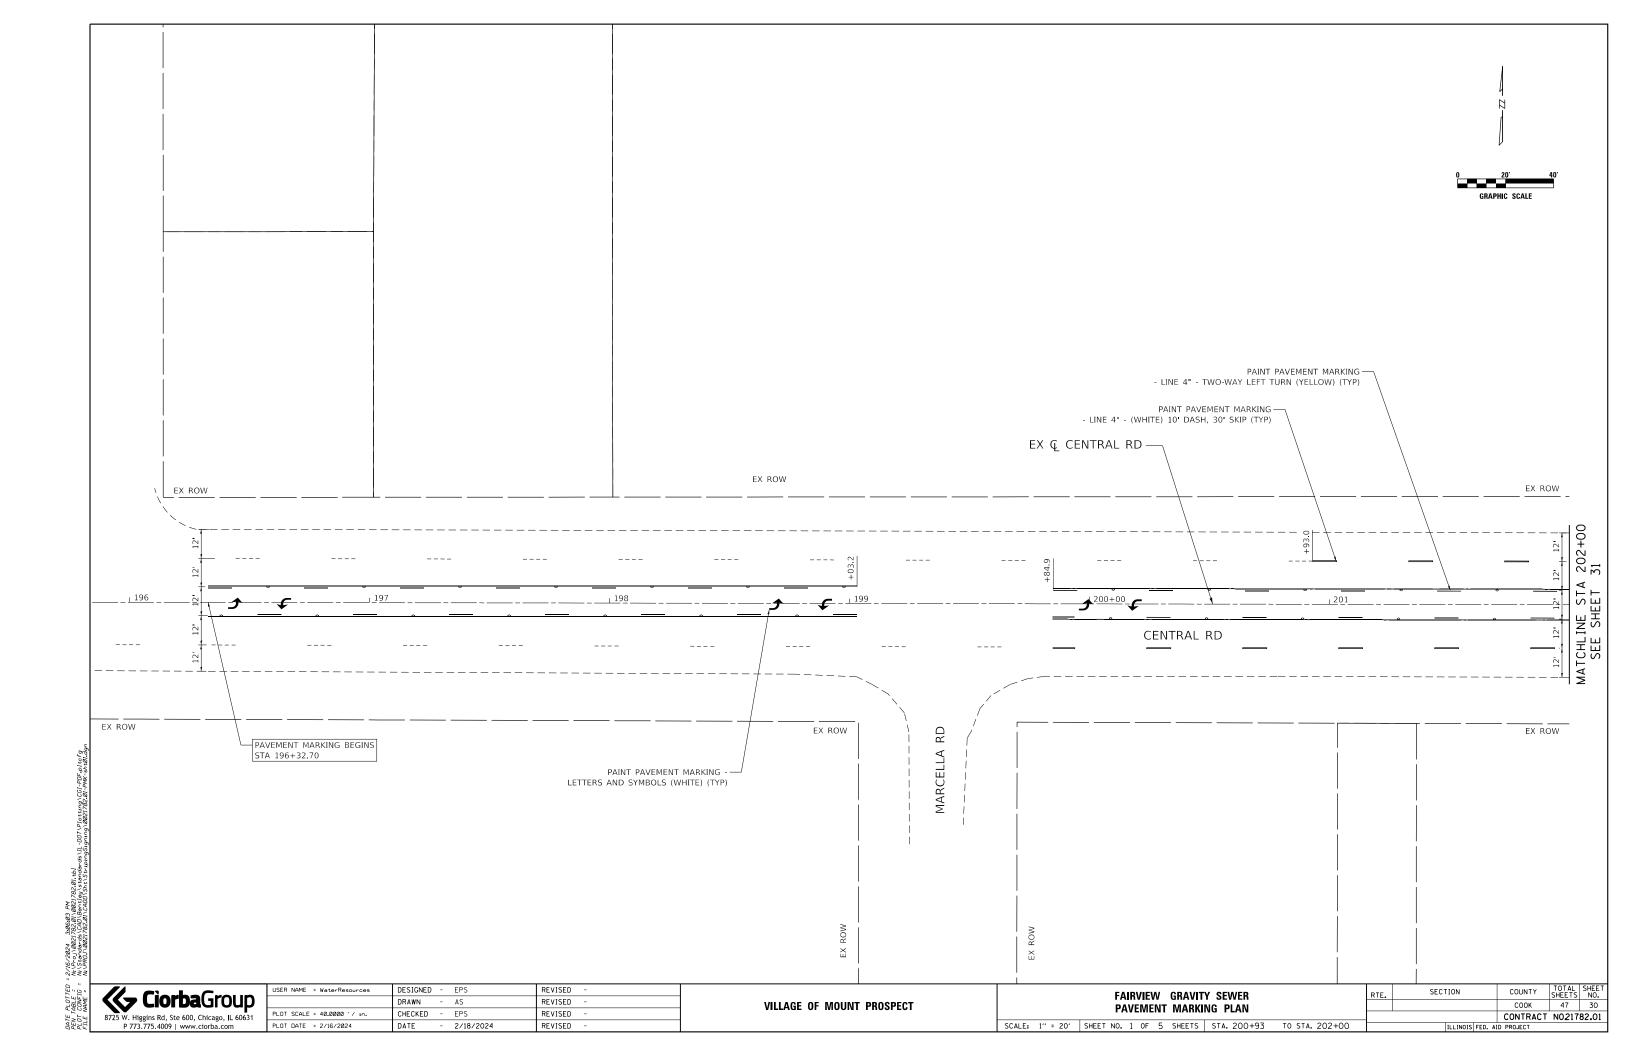
8725 W. Higgins Rd, Ste 600, Chicago, IL 60631


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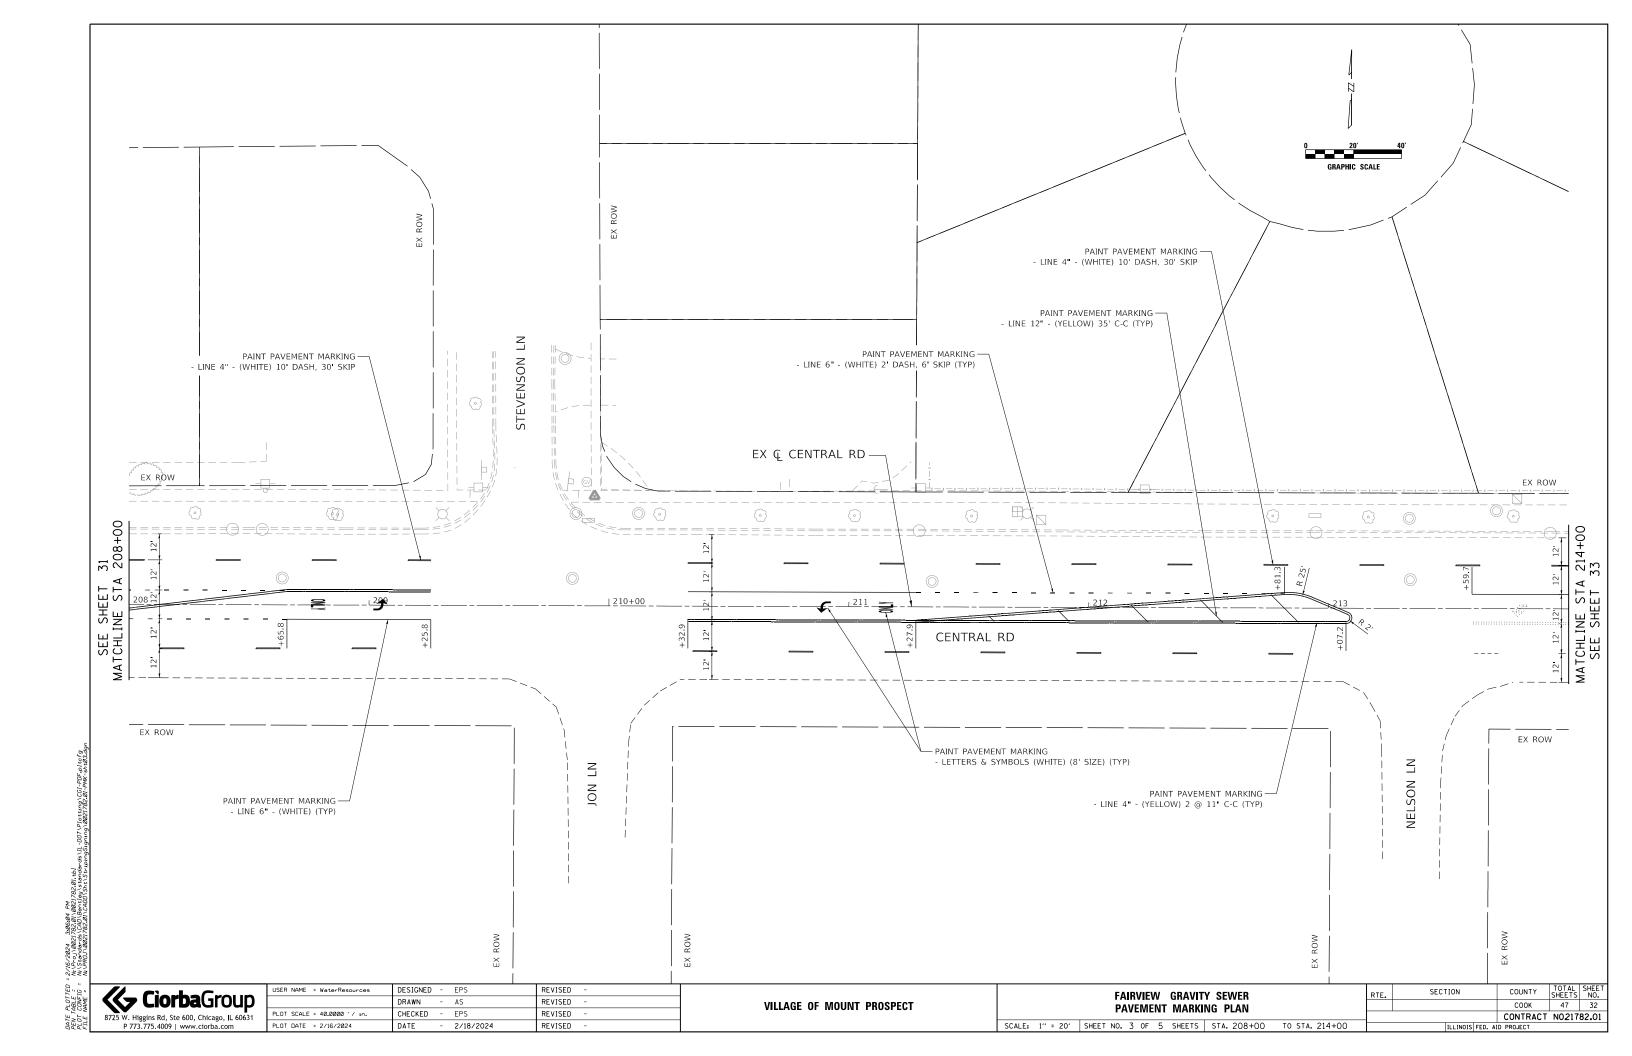
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	DRAWN	-	CLG	REVISED	-
PLOT SCALE =	CHECKED	-	LAM	REVISED	-
PLOT DATE = 2/16/2024	DATE	-	2/18/2024	REVISED	-


VILLAGE	0F	MOUNT	PROSPECT


FAIRVIEW GRAVITY SEWER	RTE.	SECTION	COUNTY	TOTAL SHEETS	SHEET NO.
EROSION CONTROL AND RESTORATION PLAN			соок	47	29
ENGOIGH GONTHOL AND NEOTONATION 1 EAR					
SCALE: 1" = 20' SHEET NO. 3 OF 3 SHEETS STA. 214+00 TO STA	ILLINOIS FED. AID PROJECT				







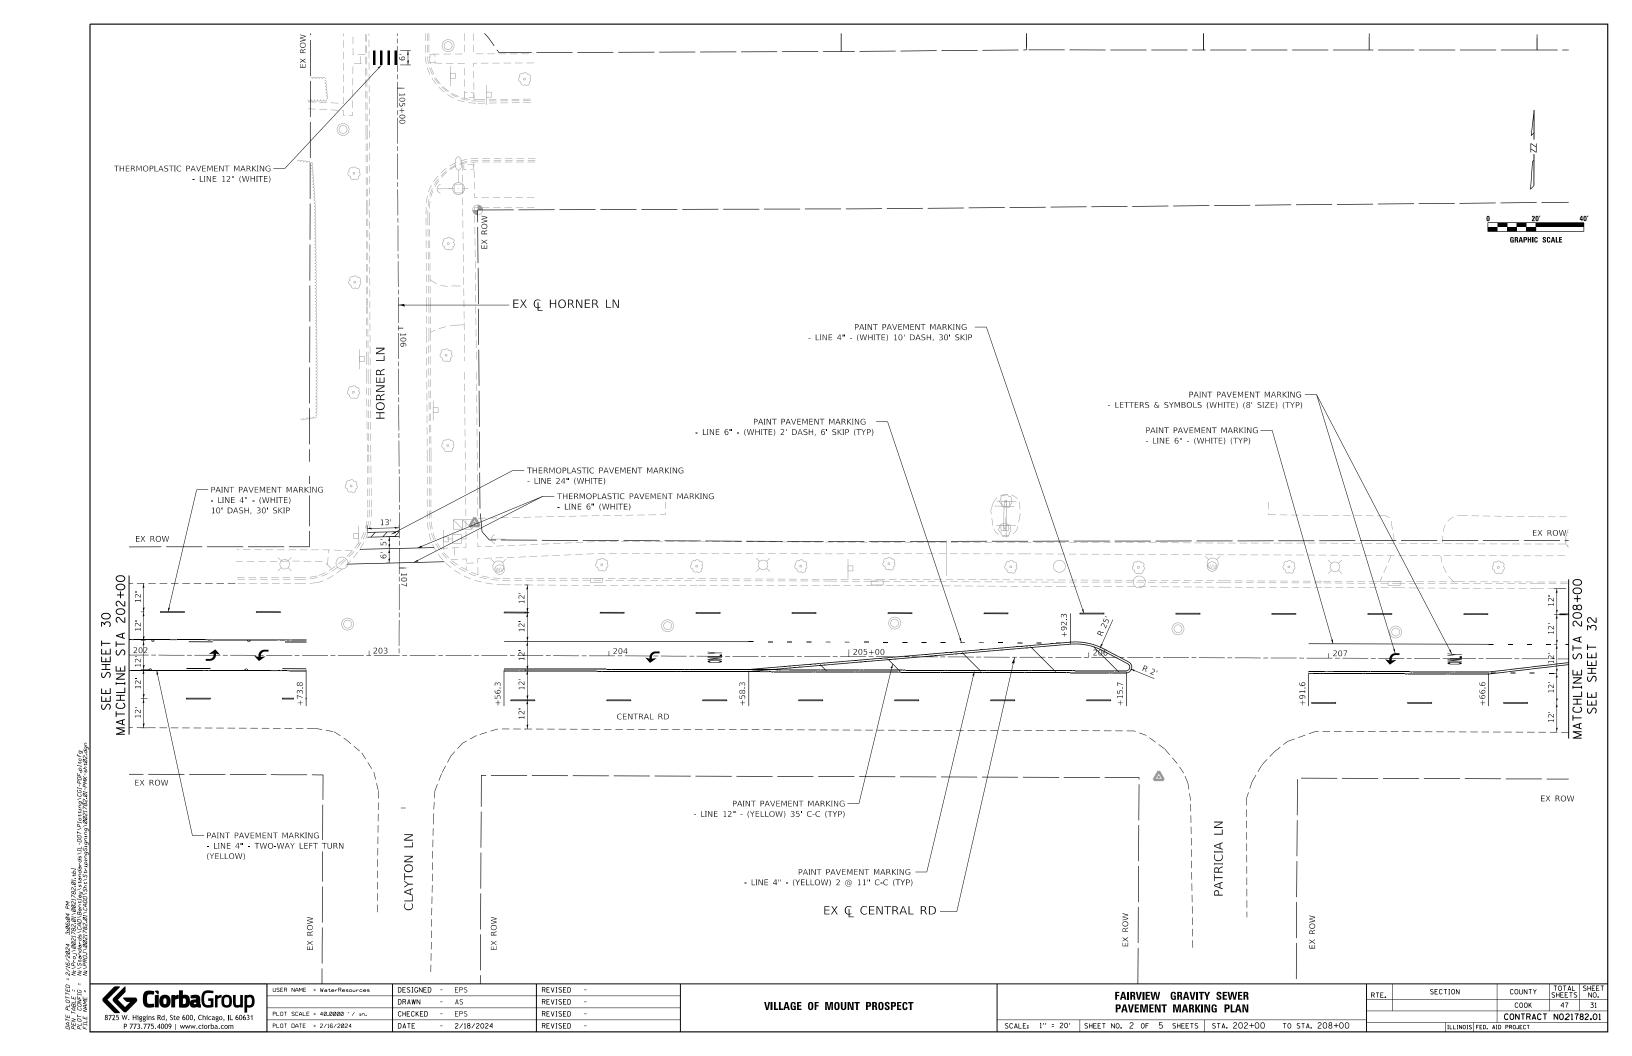


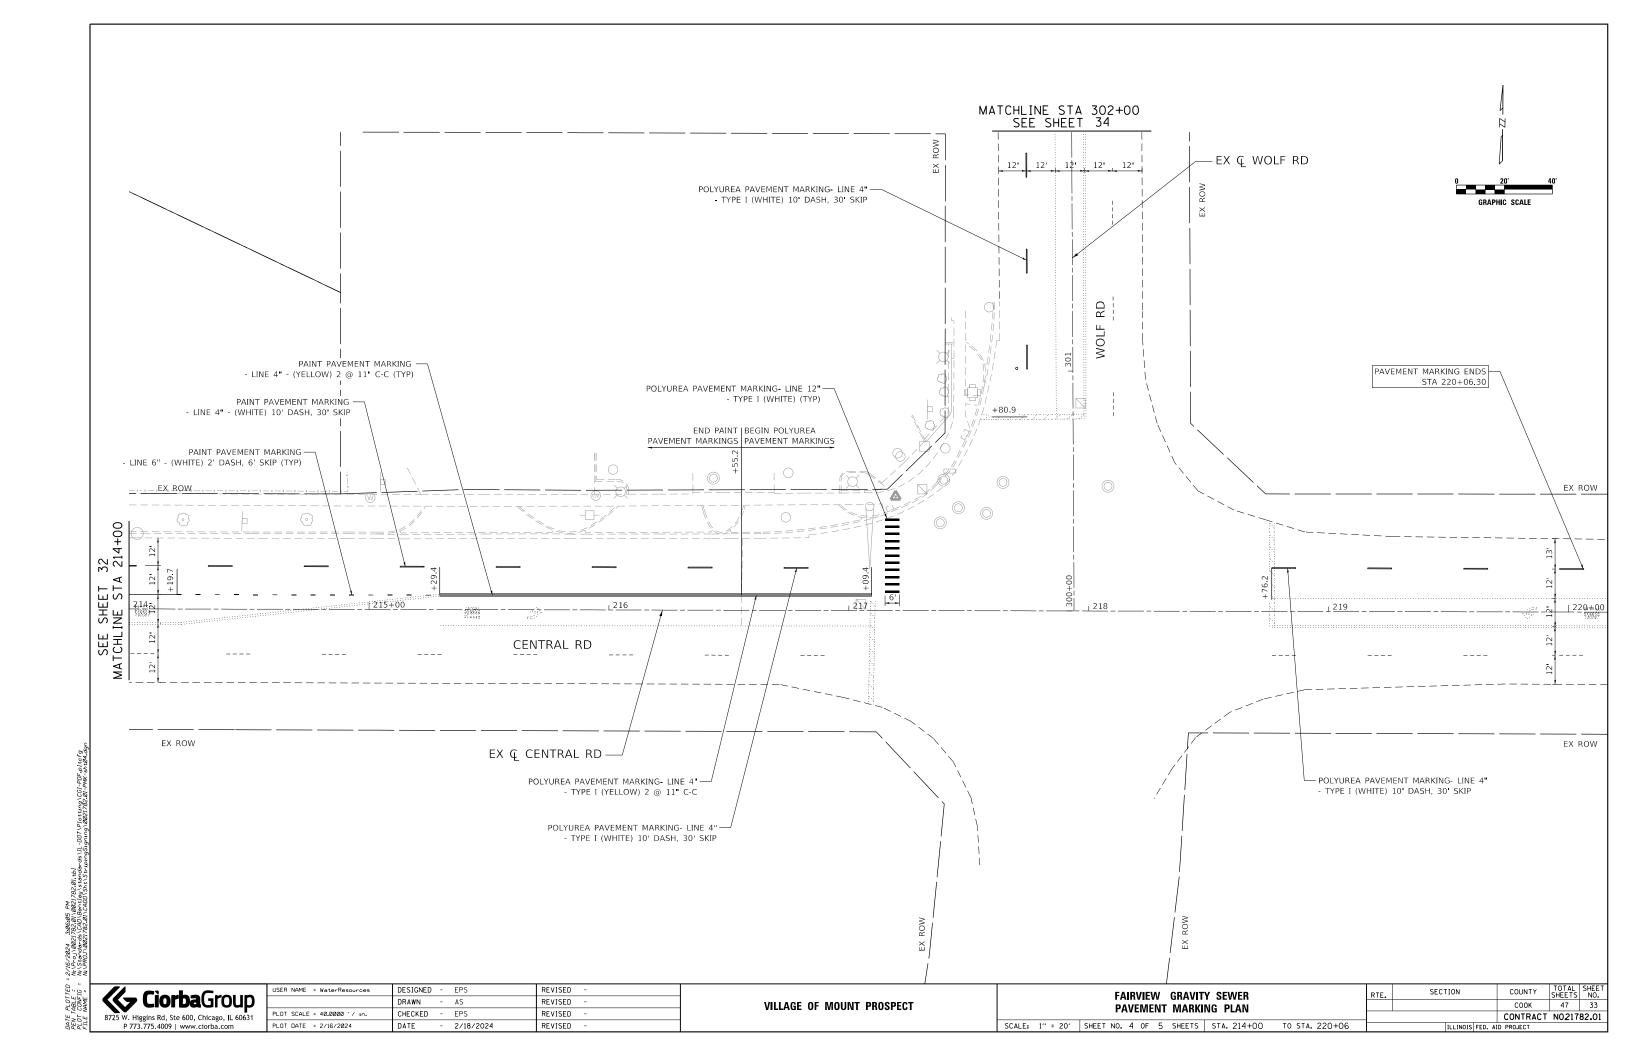

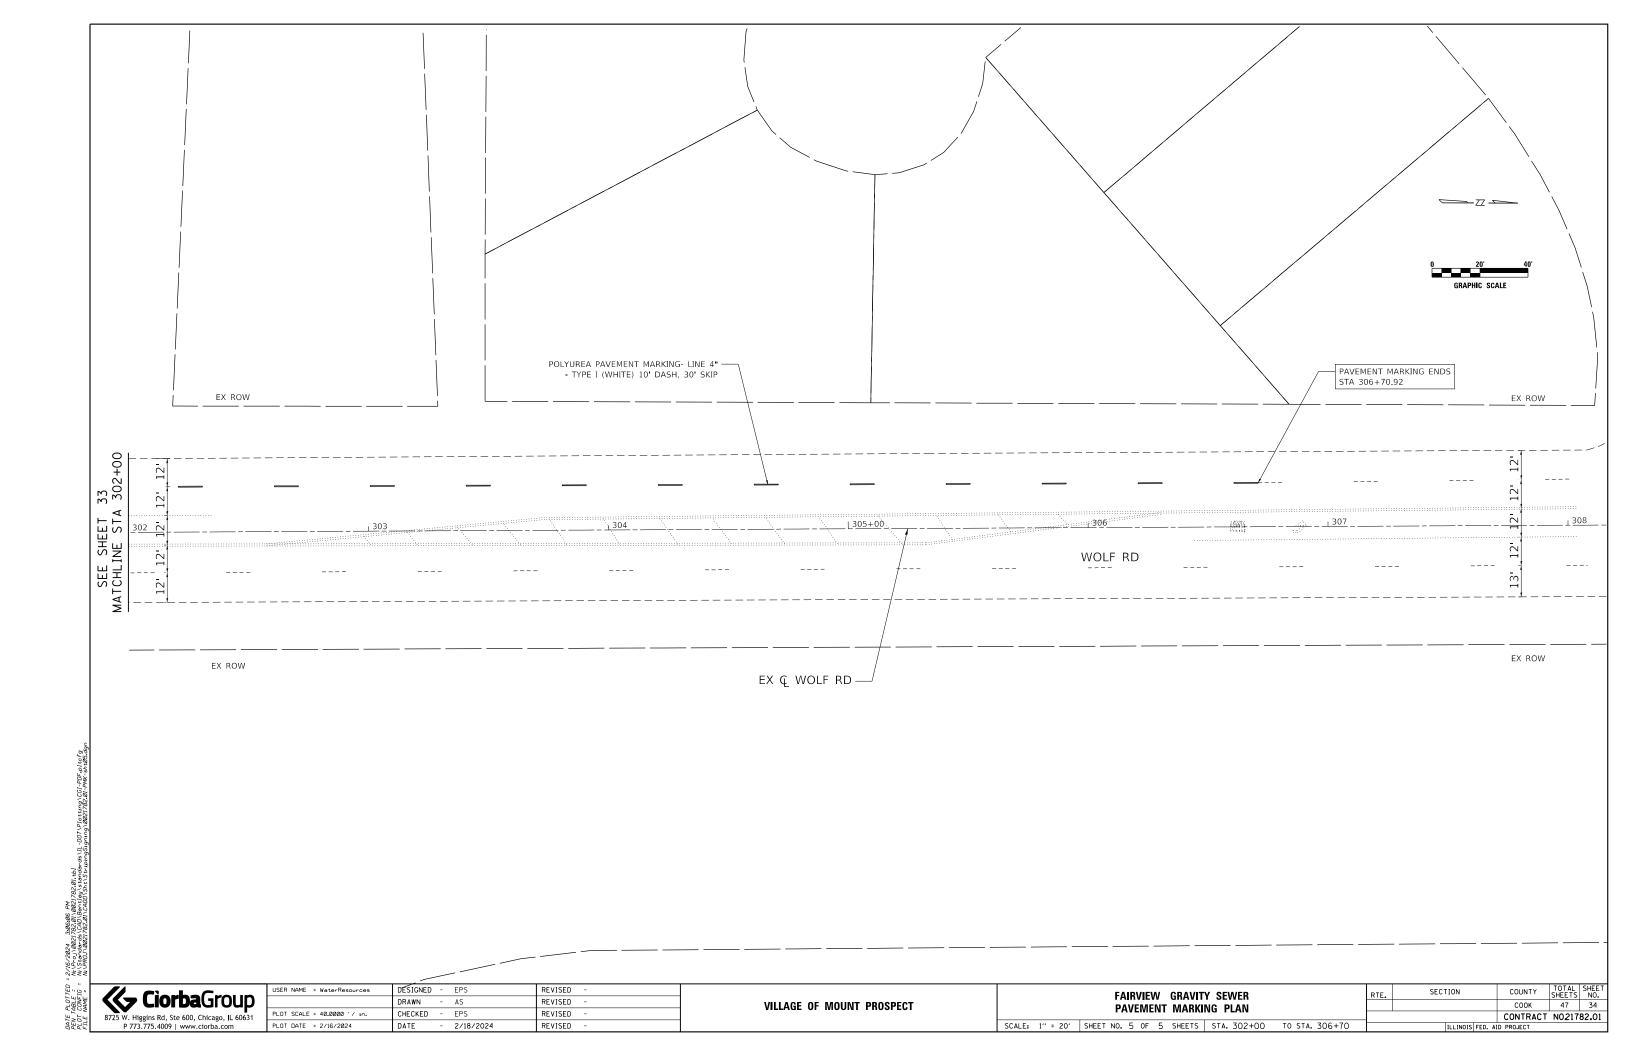

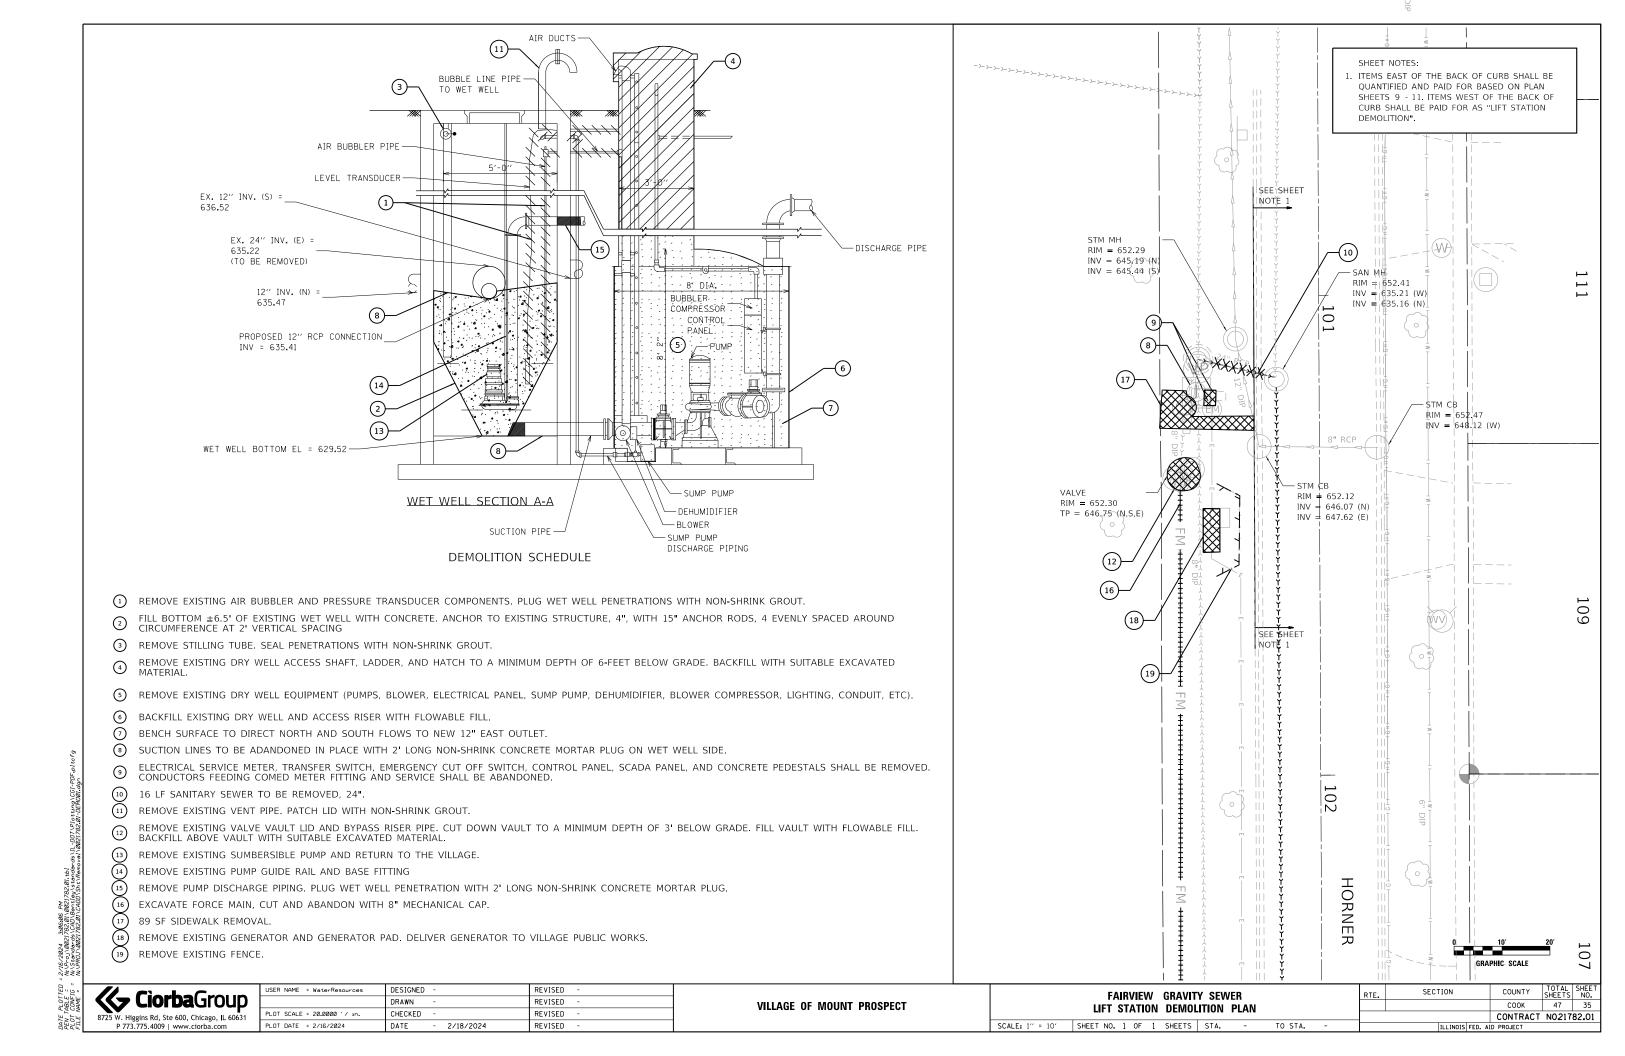

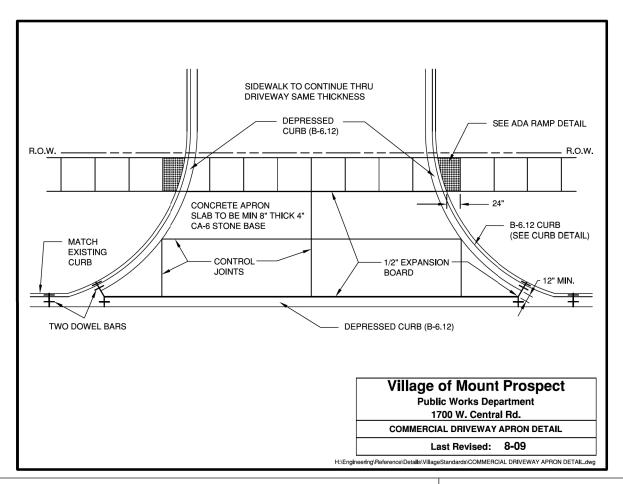


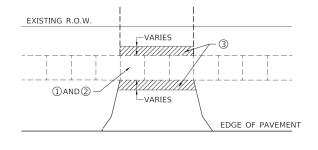


N.T.S.


- 1. PORTLAND CEMENT CONCRETE SIDEWALK, 8"
- 2. AGGREGATE BASE COURSE, TYPE B, 6", CA-6
- 3. HOT-MIX ASPHALT SURFACE COURSE, MIX 'D', N50, 3"


HOT-MIX ASPHALT DRIVEWAY PAVEMENT, 3"

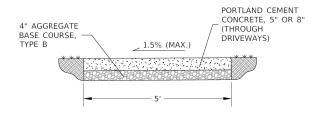


PORTLAND CEMENT CONCRETE SIDEWALK, SPECIAL

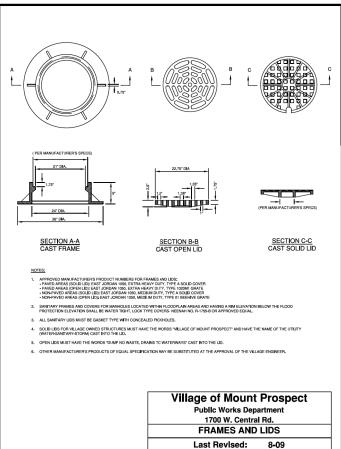

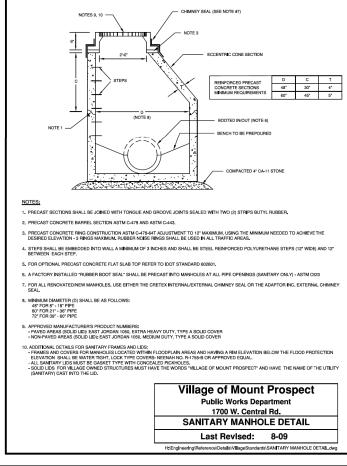


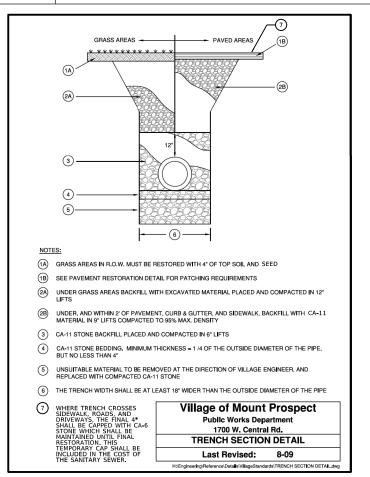

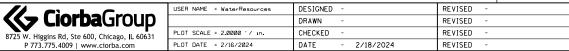


VILLAGE OF MOUNT PROSPECT

TOTAL SHEET NO. 47 36 COUNTY **FAIRVIEW GRAVITY SEWER** COOK **VILLAGE STANDARD DETAILS** CONTRACT NO21782.01 SHEET NO. 1 OF 1 SHEETS STA. TO STA.

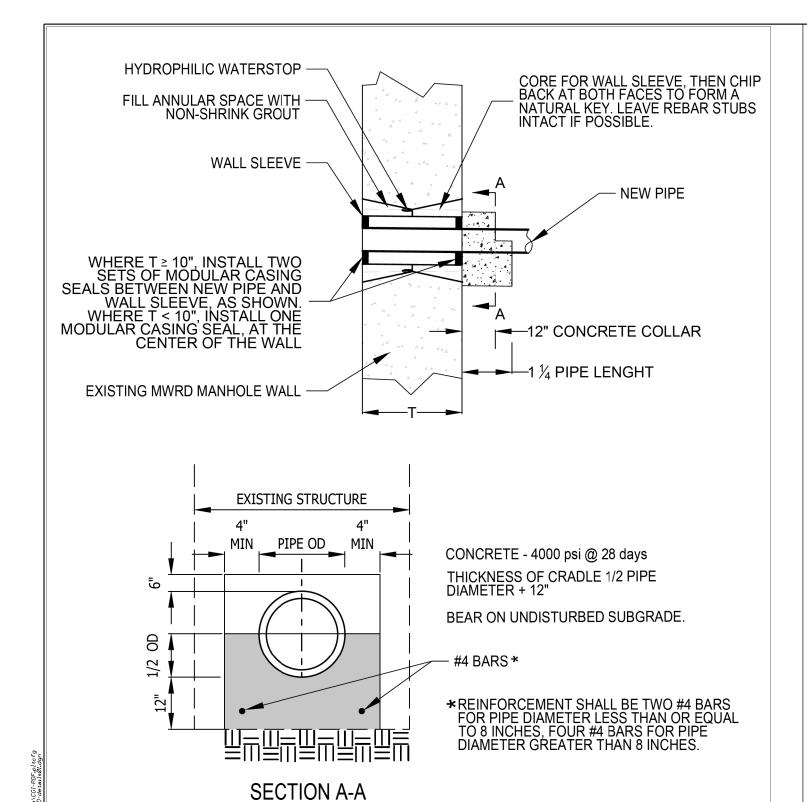


NOTE: TO BE USED WHEN CONNECTING TO DISTRICT INTERCEPTOR (SEE PAGE 38).

WER RECUAL	TECHNICAL GUIDANCE MANUAL	1/31/19
	CONCRETE CRADIE	STD. DWG. NO.30
OF CREATER CHICAGO	CONCILIE CIVADEL	PAGE NO. 31

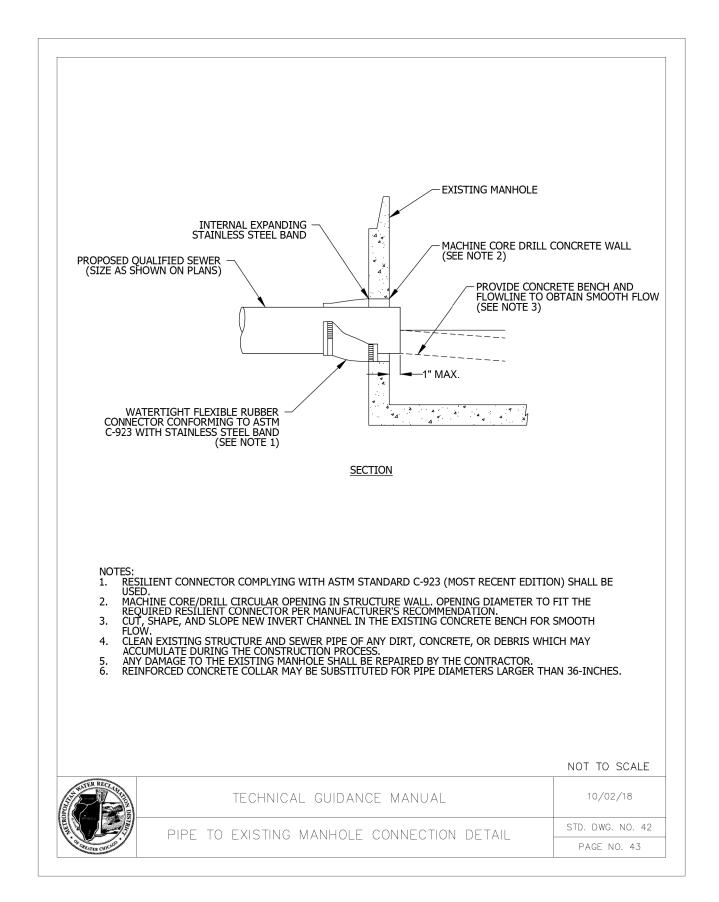

DESIGNED - LAM REVISED USER NAME = WaterResources SECTION COUNTY **Cìorba**Group **FAIRVIEW GRAVITY SEWER** DRAWN - CLG REVISED VILLAGE OF MOUNT PROSPECT COOK 47 37 MWRD DETAILS PLOT SCALE = 2.0000 '/ in. CHECKED REVISED 8725 W. Higgins Rd, Ste 600, Chicago, IL 60631 CONTRACT NO21782.01 SCALE: N.T.S. SHEET NO. 1 OF 2 SHEETS STA. PLOT DATE = 2/16/2024 TO STA. DATE - 2/18/2024 REVISED

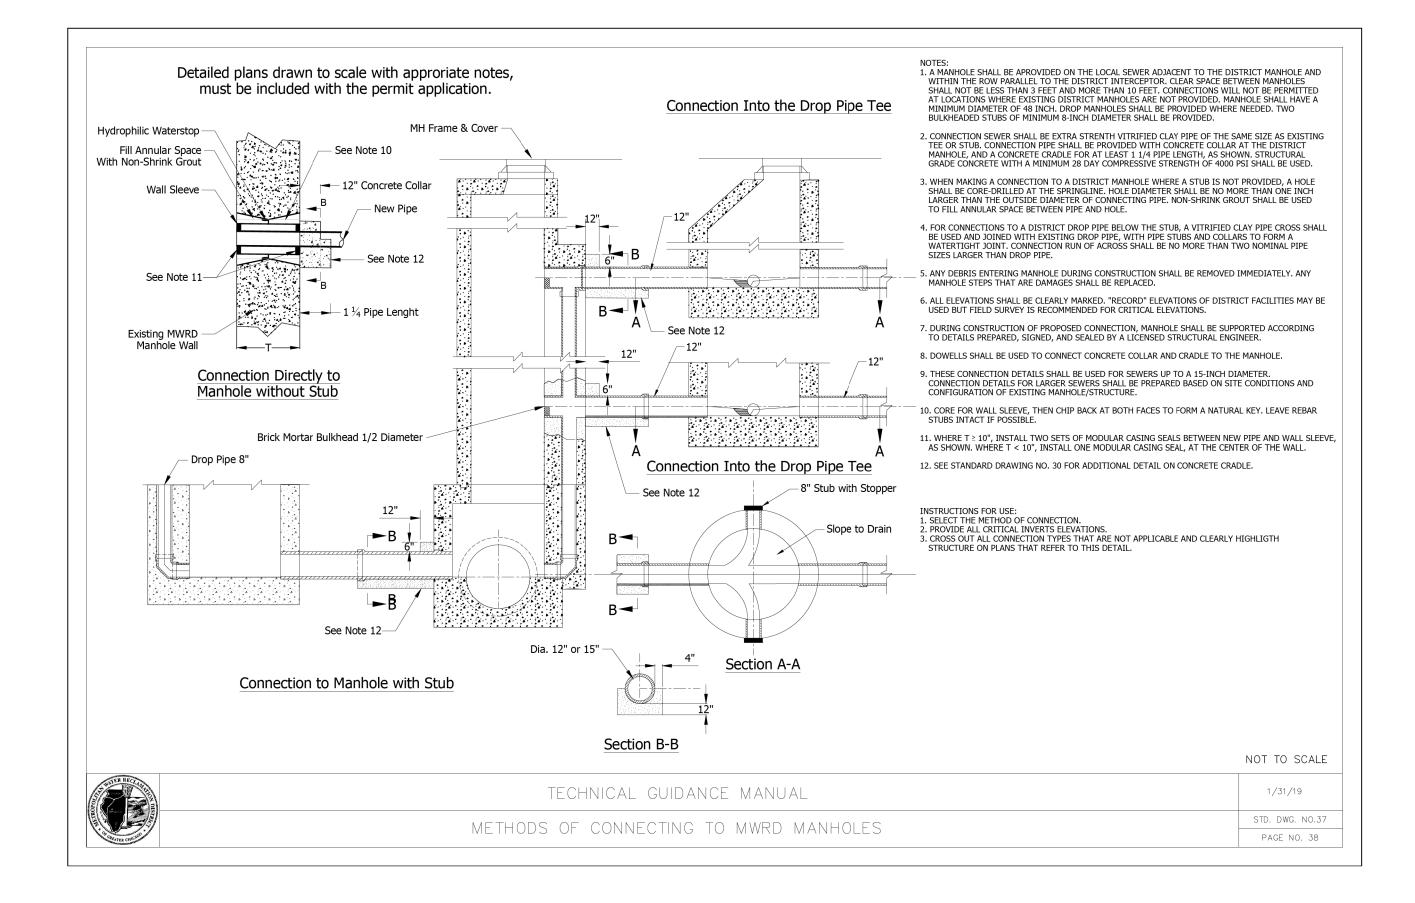

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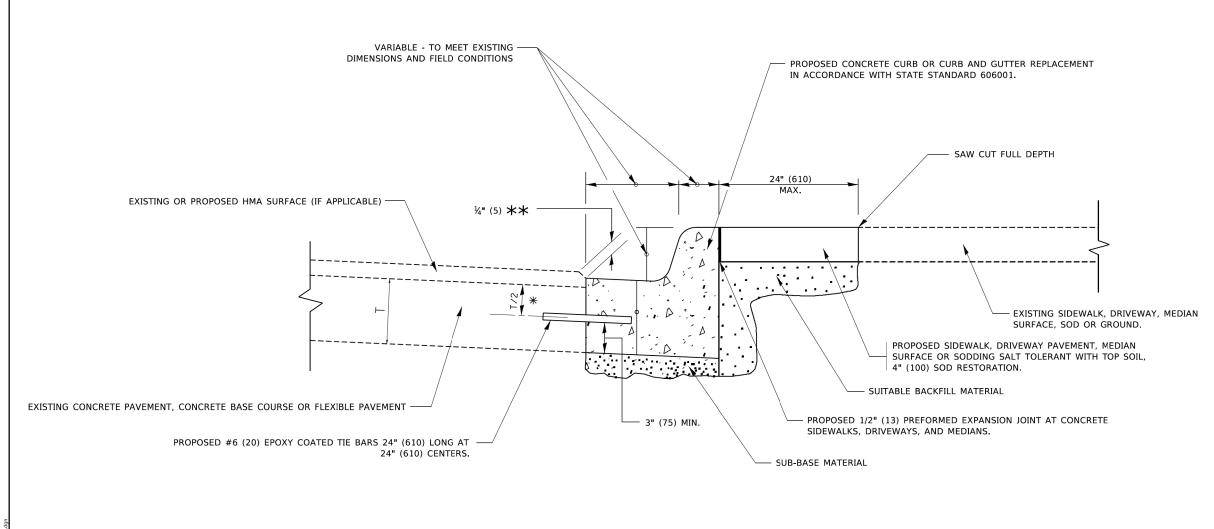
VILLAGE OF MOUNT PROSPECT

SCALE: N.T.S.

FAIRVIEW GRAVITY SEWER
MWRD DETAILS

RTE. SECTION COUNTY TOTAL SHEETS NO.
COOK 47 38.8

SHEET NO. 2 OF 2 SHEETS STA. - TO STA. - ILLINOIS FED. AID PROJECT



- ★ 3" (75) MINIMUM FROM TOP AND BOTTOM OF THE CONCRETE PAVEMENT OR BASE COURSE.
- $\star\star$ if the final surface of the pavement is concrete, the gutter is to be flush with the pavement.

CURB OR CURB AND GUTTER REMOVAL AND REPLACEMENT

ALL DIMENSIONS ARE IN INCHES (MILLIMETERS) UNLESS OTHERWISE SHOWN.

USER NAME = footemj	DESIGNED - A. HOUSEH	REVISED - A. ABBAS 03-21-97			CURB OR CURB AND GUTTER		F.A. RTE.	SECTION	COUNTY	TOTAL SHEET SHEETS NO.
	DRAWN -	REVISED - M. GOMEZ 01-22-01	STATE OF ILLINOIS DEPARTMENT OF TRANSPORTATION	REMOVAL AND REPLACEMENT						
PLOT SCALE = 50.0000 ' / in.	CHECKED -	REVISED - R. BORO 12-15-09						BD600-06 (BD-24)	CONTRACT	NO.
PLOT DATE = 7/11/2019	DATE - 03-11-94	REVISED - K. SMITH 07-11-19		SCALE: NONE	SHEET 1 OF 1 SHEETS STA.	TO STA.		ILLINOIS FED. A	ID PROJECT	

SCALE: N.T.S.


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	USER NAME = WaterResources	DESIGNED	-	EPS	REVISED -
		DRAWN	-	AS	REVISED -
	PLOT SCALE = 20.0000 '/ in.	CHECKED	-	EPS	REVISED -
	PLOT DATE = 2/16/2024	DATE	-	2/18/2024	REVISED -
7					

VILLAGE	0F	MOUNT	PROSPECT

	EVID	VIEV	v	CBAVIT	V CEW	FD			RTE.	SECTION	COUNTY	TOTAL SHEETS	SHEET NO.
FAIRVIEW GRAVITY SEWER IDOT DISTRICT ONE DETAIL										соок	47	39	
IDOT DISTRICT ONE DETAIL											CONTRACT	NO217	82.01
	SHEET NO. 1	OF	6	SHEETS	STA.	-	TO STA.	-		ILLINOIS FED	. AID PROJECT		

11.E = N.YF-o,V0021782,01\0021782.01.tb| NNFIG = N.YEcandards\(CAD\0021792.01.td| NNFIG = N.YECANDARDS\(CAD\0021792.01.Cd)\(CAD\0021792.01.01.td|\0021792.01.Cd)\(CAD\

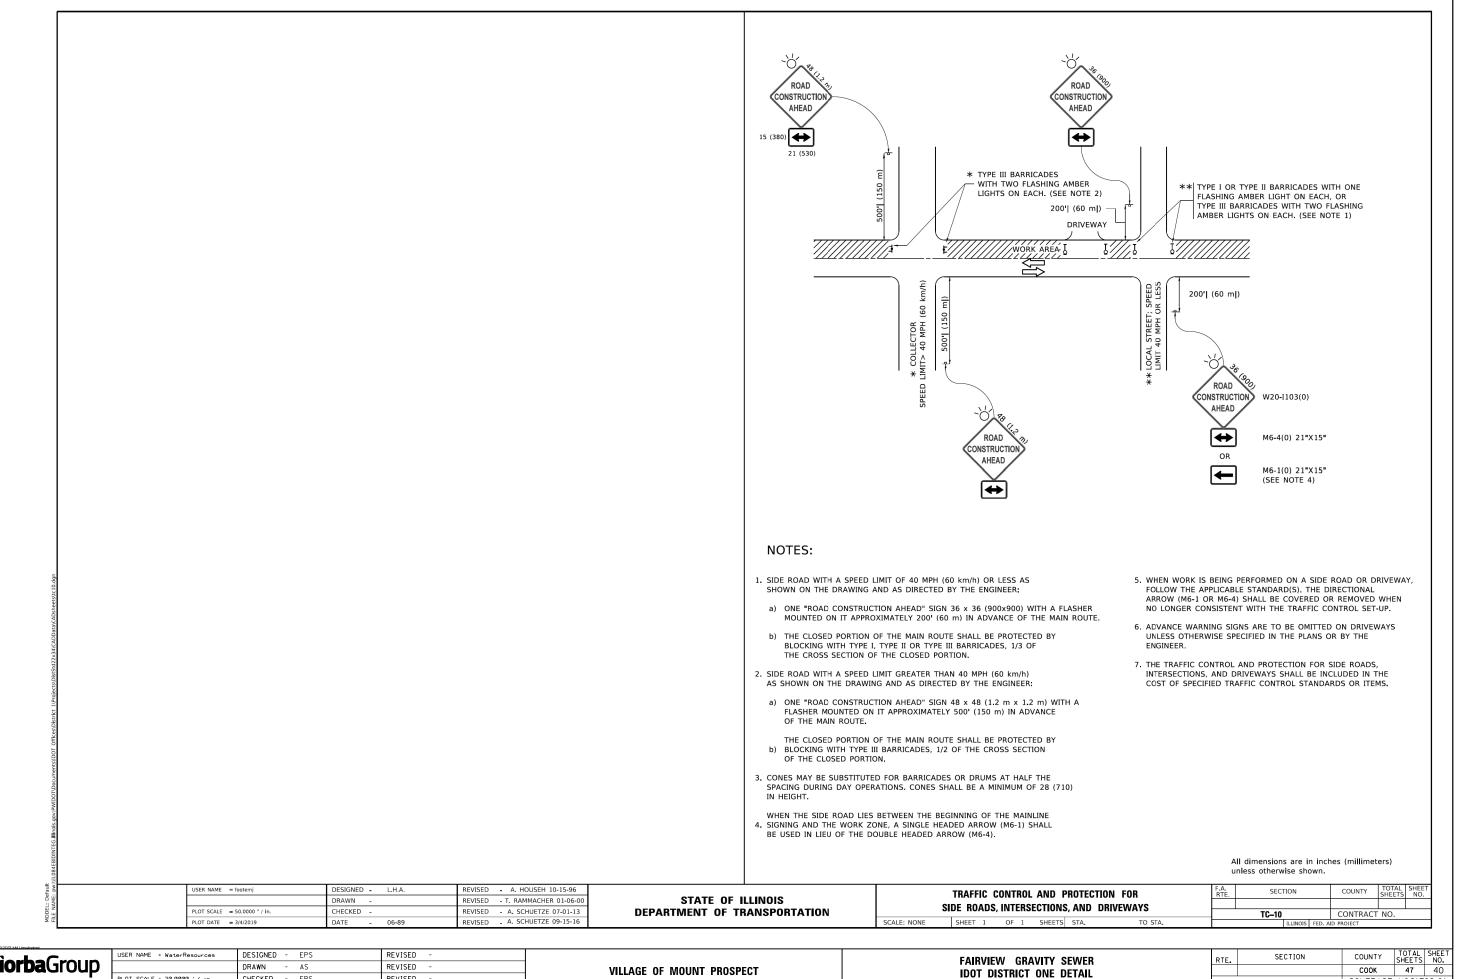

SCALE: N.T.S.

SHEET NO. 2 OF 6 SHEETS STA.

TO STA.

CONTRACT NO21782.01

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PLOT SCALE = 20.0000 '/ in.

PLOT DATE = 2/16/2024

CHECKED


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- EPS

- 2/18/2024

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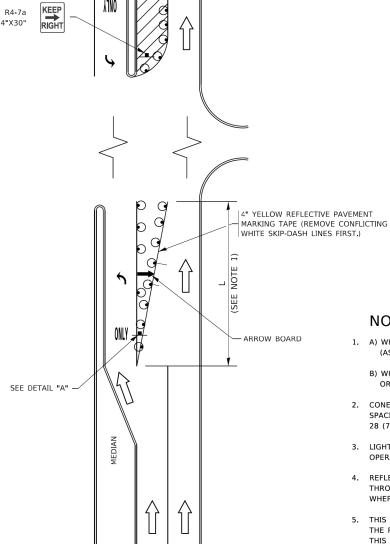
8725 W. Higgins Rd, Ste 600, Chicago, IL 60631

DRAWN - AS REVISED PLOT SCALE = 20.0000 '/ in. CHECKED - EPS REVISED PLOT DATE = 2/16/2024 DATE REVISED - 2/18/2024

VILLAGE OF MOUNT PROSPECT

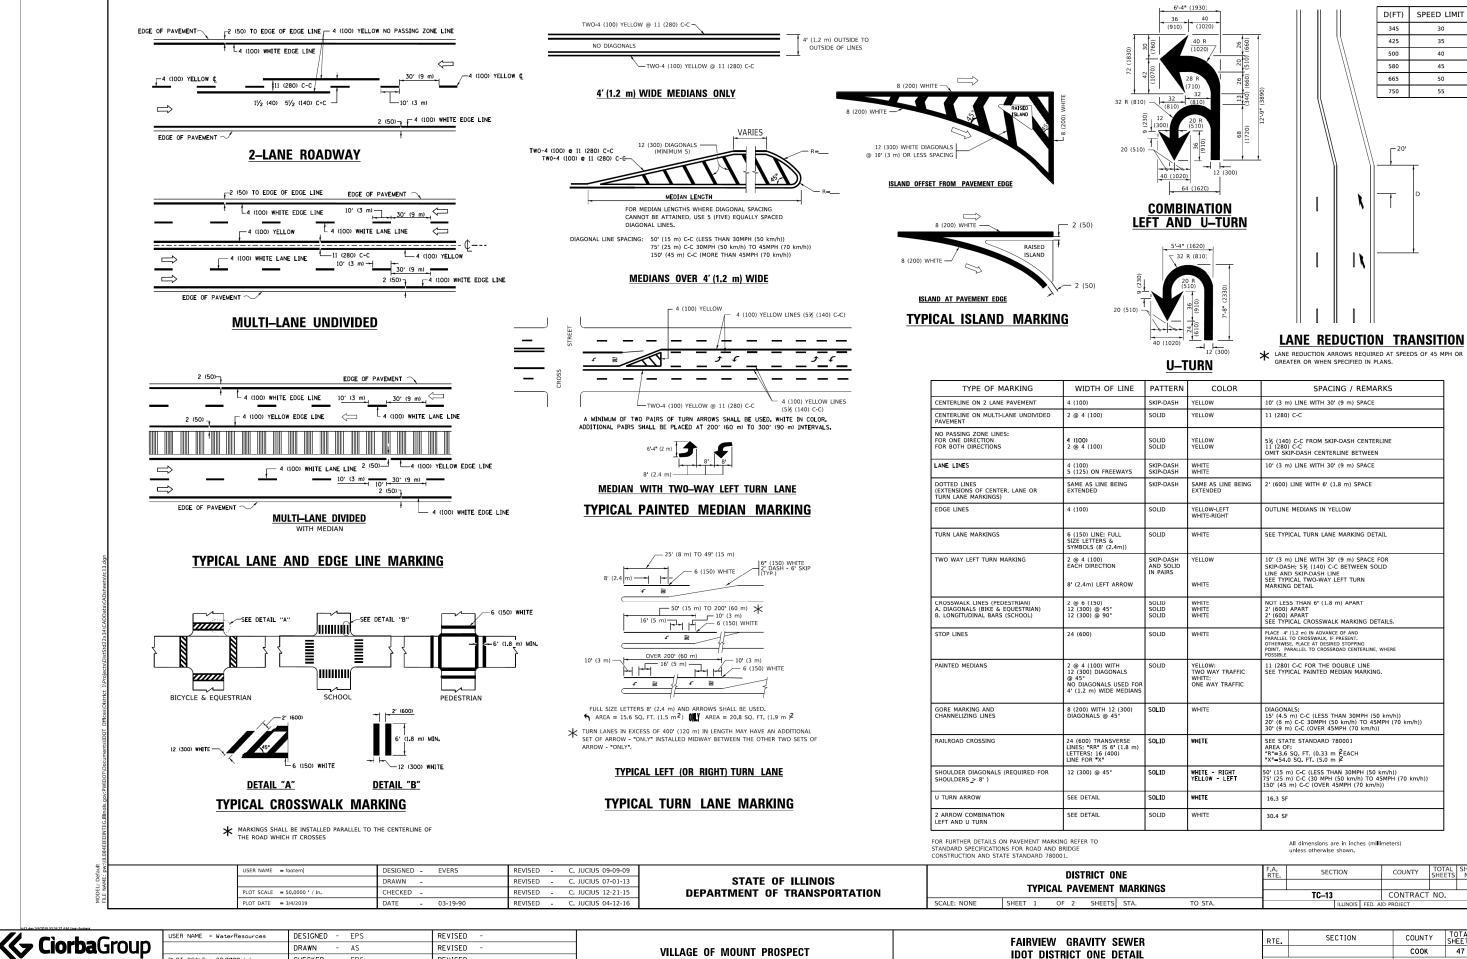FAIRVIEW GRAVITY SEWER 47 41 COOK **IDOT DISTRICT ONE DETAIL** CONTRACT NO21782.01 SHEET NO. 3 OF 6 SHEETS STA. TO STA.

TURN BAY ENTRANCE AT START OF LANE CLOSURE TAPER




WORK AREA LANE OPEN TO TRAFFIC ARROW BOARD TYPE I OR II BARRICADE OR DRUM WITH STEADY BURN LIGHT DRUM WITH STEADY BURN LIGHT SIGN ASSEMBLY TYPE I OR II CHECK BARRICADE WITH FLASHING LIGHT

NOTES:

- 1. A) WHEN "L" IS \leq THE STORAGE LENGTH OF THE TURN LANE (AS SHOWN IN FIG. 1), USE FIGURE 1.
 - B) WHEN "L" IS > THE STORAGE LENGTH OF THE TURN LANE OR THE TURN LANE IS WITHIN THE LANE CLOSURE, USE FIGURE 2.
- CONES MAY BE SUBSTITUTED FOR BARRICADES OR DRUMS AT HALF THE SPACING DURING DAY OPERATIONS. CONES SHALL BE A MINIMUM OF 28 (710) IN HEIGHT.
- LIGHTS WILL NOT BE REQUIRED ON BARRICADES OR DRUMS FOR DAY OPERATIONS. ALL LIGHTS SHALL BE MONODIRECTIONAL.
- 4. REFLECTIVE TEMPORARY PAVEMENT MARKINGS SHALL BE PLACED THROUGHOUT THE BARRICADED AREAS OF EACH TURN BAY AS SHOWN WHERE THE CLOSURE TIME IS GREATER THAN FOURTEEN (14) DAYS.
- 5. THIS APPLICATION ALSO APPLIES WHEN WORK IS BEING PERFORMED IN THE RIGHT LANE(S) AND THE RIGHT TURN BAY IS TO REMAIN OPEN. UNDER THIS CONDITION, "RIGHT TURN LANE" R3-1100R 24 x 24 (600 x 600) AND M6-2R 21 x 15 (530 x 380) SHALL BE USED.
- THESE CONTROLS SHALL SUPPLEMENT MAINLINE TRAFFIC CONTROL FOR LANE CLOSURES.
- THE SIGNS SHALL BE MOUNTED ABOVE THE BARRICADES/DRUMS ON SEPARATE SIGN SUPPORTS THAT MEET NCHRP 350 OR MASH PREOUIREMENTS.
- TRAFFIC CONTROL AND PROTECTION AT TURN BAYS (TO REMAIN OPEN TO TRAFFIC) SHALL BE INCLUDED IN THE COST OF SPECIFIED TRAFFIC CONTROL STANDARDS OR ITEMS.

TURN BAY ENTRANCE WITHIN A LANE CLOSURE

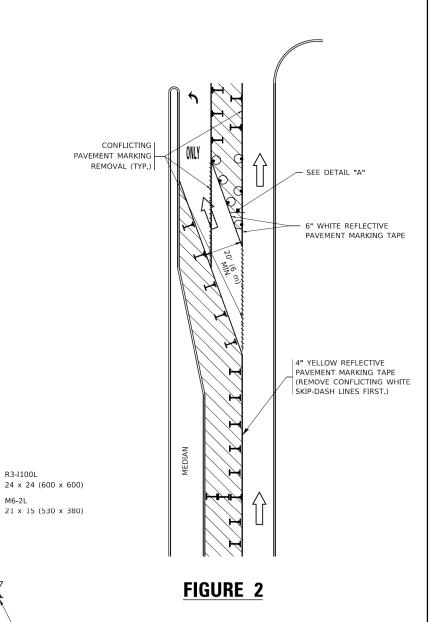

DETAIL A

STABILIZE SIGN

All dimensions are in inches (millimeters) unless otherwise shown.

PLOT SCALE = 50.0000 '/ in. CHECKED - A. HOUSEH 11-07-95 REVISED - A. SCHUETZE 07-01-13 STATE OF ILLINOIS PLOT SCALE = 50.0000 '/ in. CHECKED - A. HOUSEH 10-12-96 REVISED - A. SCHUETZE 09-15-16 DEPARTMENT OF TRANSPORTATION TC-14 CONTRACT NO.	USER NAME = footemj	DESIGNED -T. RAMMACHER 09-08-94	REVISED - R. BORO 09-14-09		TRAFFIC C	ONTROL AND PROTECTION AT TURN	I RAVS	RTF	SECTION	COUNTY SHEETS NO
TC-14 CONTRACT NO.		DRAWN - A. HOUSEH 11-07-95	REVISED - A. SCHUETZE 07-01-13	STATE OF ILLINOIS			BA10	TOTAL.		SHEETS NO.
	PLOT SCALE = 50.0000 ' / in.	CHECKED - A. HOUSEH 10-12-96	REVISED - A. SCHUETZE 09-15-16	DEPARTMENT OF TRANSPORTATION		(TO REMAIN OPEN TO TRAFFIC)	F			CONTRACT NO.
SCALE, NOTE STILL STA, TO STA,	PLOT DATE = 3/4/2019	DATE -T. RAMMACHER 01-06-00	REVISED -		SCALE: NONE SHEE	T 1 OF 1 SHEETS STA.	TO STA.		ILLINOIS FED. AI	D PROJECT

SCALE: N.T.S.



USER NAME = WaterResources	DESIGNED	-	EPS	REVISED -
	DRAWN	-	AS	REVISED -
PLOT SCALE = 20.0000 '/ in.	CHECKED	-	EPS	REVISED -
PLOT DATE = 2/16/2024	DATE	-	2/18/2024	REVISED -


FIGURE 1

VILLAGE OF MOUNT PROSPECT

FAIRVIEW GRAVITY SEWER
IDOT DISTRICT ONE DETAIL

SHEET NO. 4 OF 6 SHEETS STA. - TO STA. - IILLINOIS FI

. - K.10./2024 - - K.10./2021/82/81/0021/82/81,tbl - - Nt.Standerds\CAD\Sentley\standerds\\L-DOT\Plottn - Nt\PROJ\0021/82/81\CADD\Sht\Details\0021/82/81-Dr

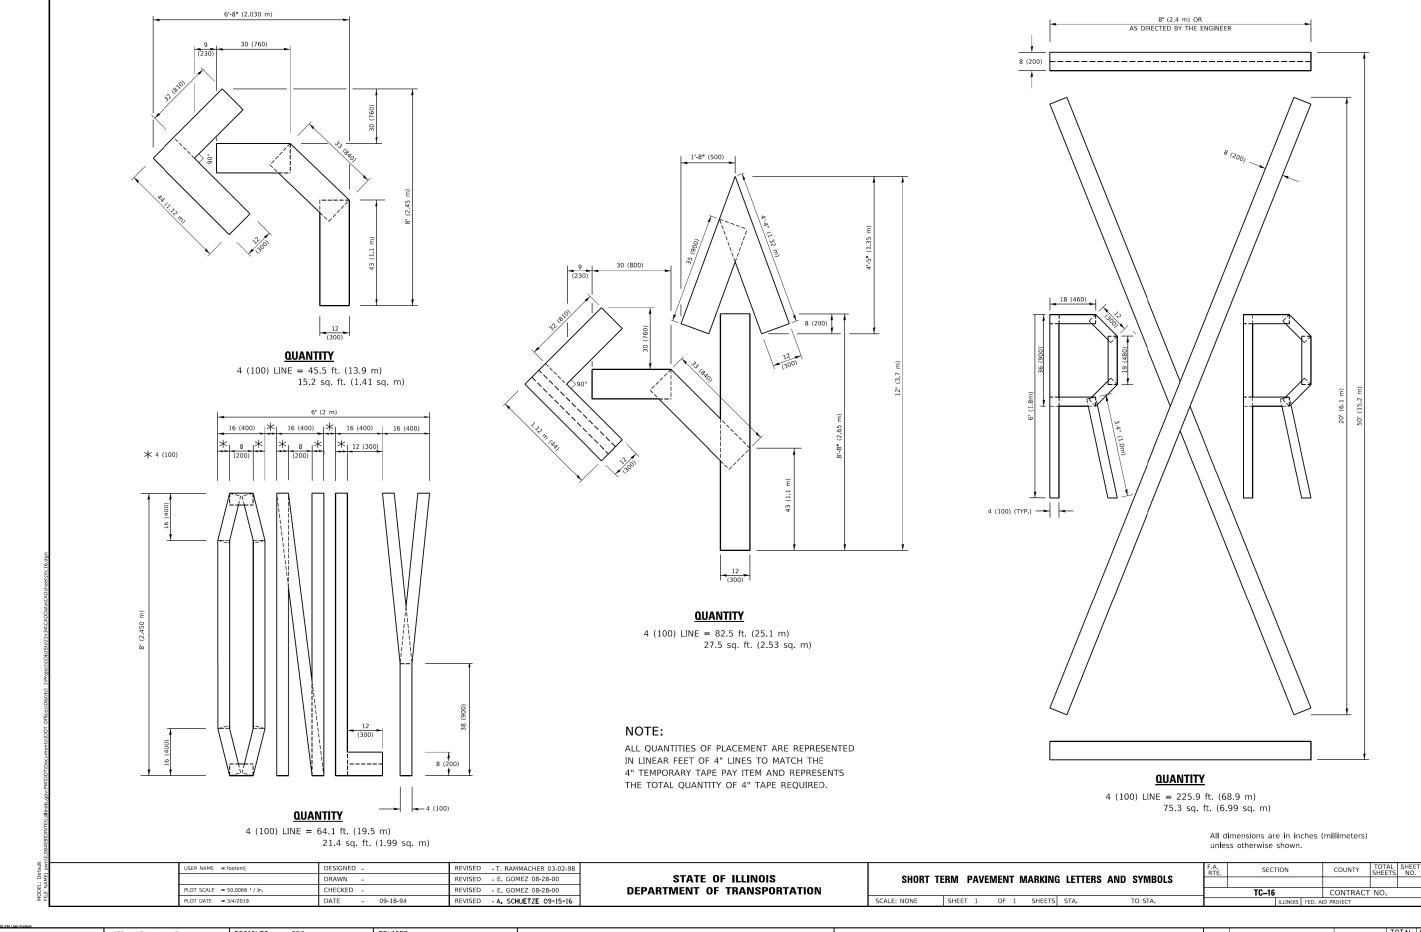

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 PLOT SCALE = 20.0000 '/ in.
 CHECKED
 EPS
 REVISED

 PLOT DATE
 = 2/16/2024
 DATE
 2/18/2024
 REVISED

VILLAGE OF MOUNT PROSPECT

FAIRVIEW GRAVITY SEWER
IDOT DISTRICT ONE DETAIL

SCALE: N.T.S. SHEET NO. 5 OF 6 SHEETS STA. - TO STA. - ILLINOIS FED. AID PROJECT

RTE. SECTION COUNTY TOTAL SHEET NO. 6 SHEETS NO. 201782.01

RTE. SECTION COUNTY TOTAL SHEET NO. 6 SHEETS NO. 47 43

CONTRACT NO. 21782.01

VILLAGE OF MOUNT PROSPECT

соок

CONTRACT NO21782.01

IDOT DISTRICT ONE DETAIL

TO STA.

SHEET NO. 6 OF 6 SHEETS STA.

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DRAWN

DATE

PLOT SCALE = 20.0000 '/ in.

PLOT DATE = 2/16/2024

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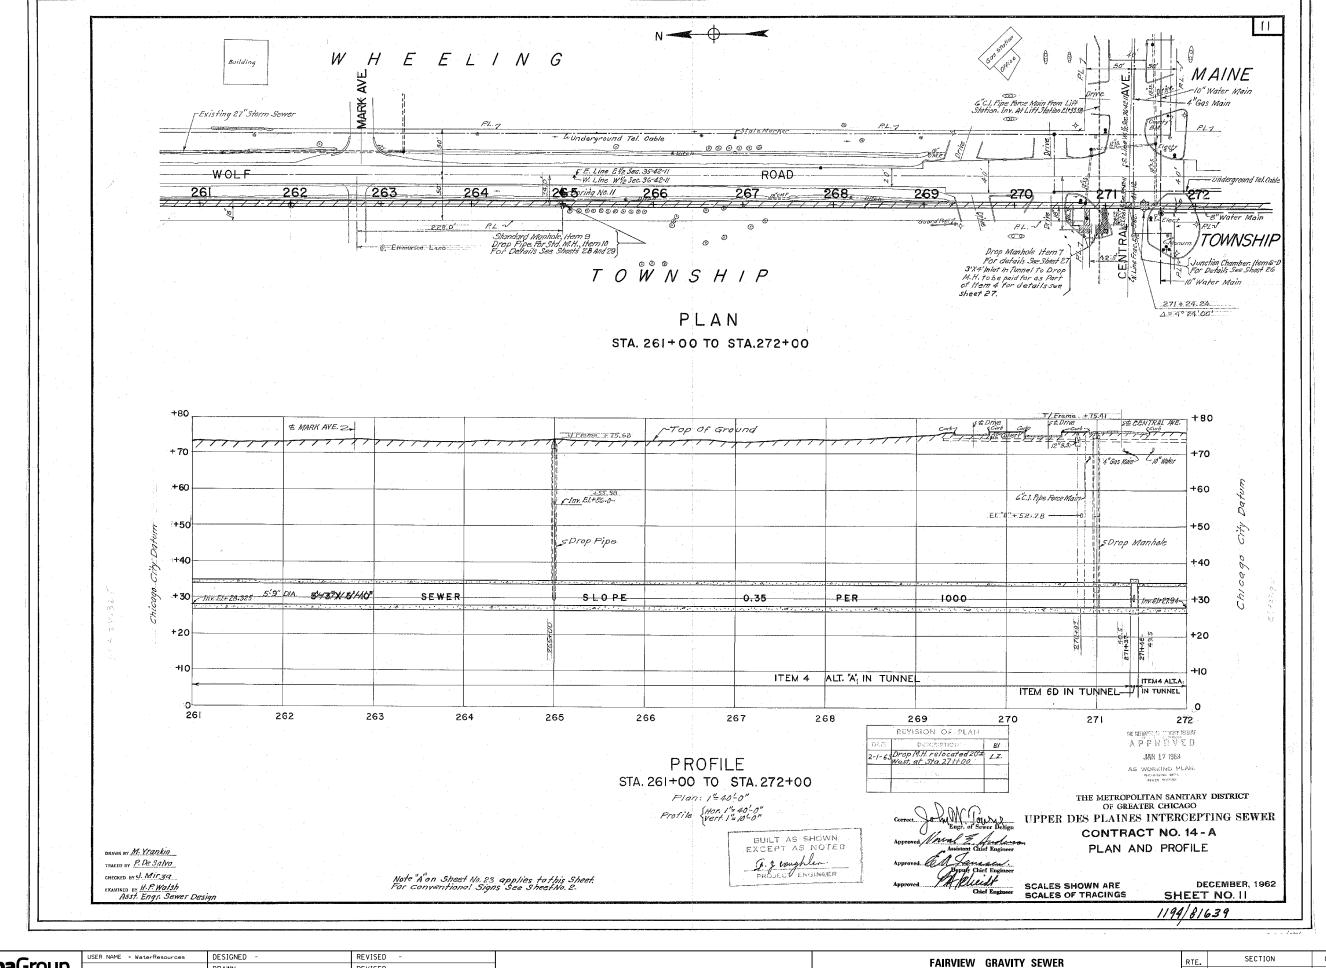
- 2/18/2024

CHECKED - EPS

REVISED

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REVISED




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USER NAME = WaterResources	DESIGNED -	REVISED	-
	DRAWN -	REVISED	-
PLOT SCALE = 2.0000 '/ in.	CHECKED -	REVISED	-
PLOT DATE = 2/16/2024	DATE - 2/18/	2024 REVISED	-

VILLAGE	0F	MOUNT	PROSPECT

	FAIRVIEV	V GRAVIT	RTE.	SECTION	COUNTY	TOTAL SHEETS	SHEET NO.				
REFERENCE DRAWINGS									COOK	47	45
				CONTRACT	NO217	82.01					
SCALE: N.T.S.	SHEET NO. 1 OF	3 SHEETS	STA.	-	TO STA.	-		ILLINOIS FED. A	ID PROJECT		



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8725 W. Higgins Rd, Ste 600, Chicago, IL 60631

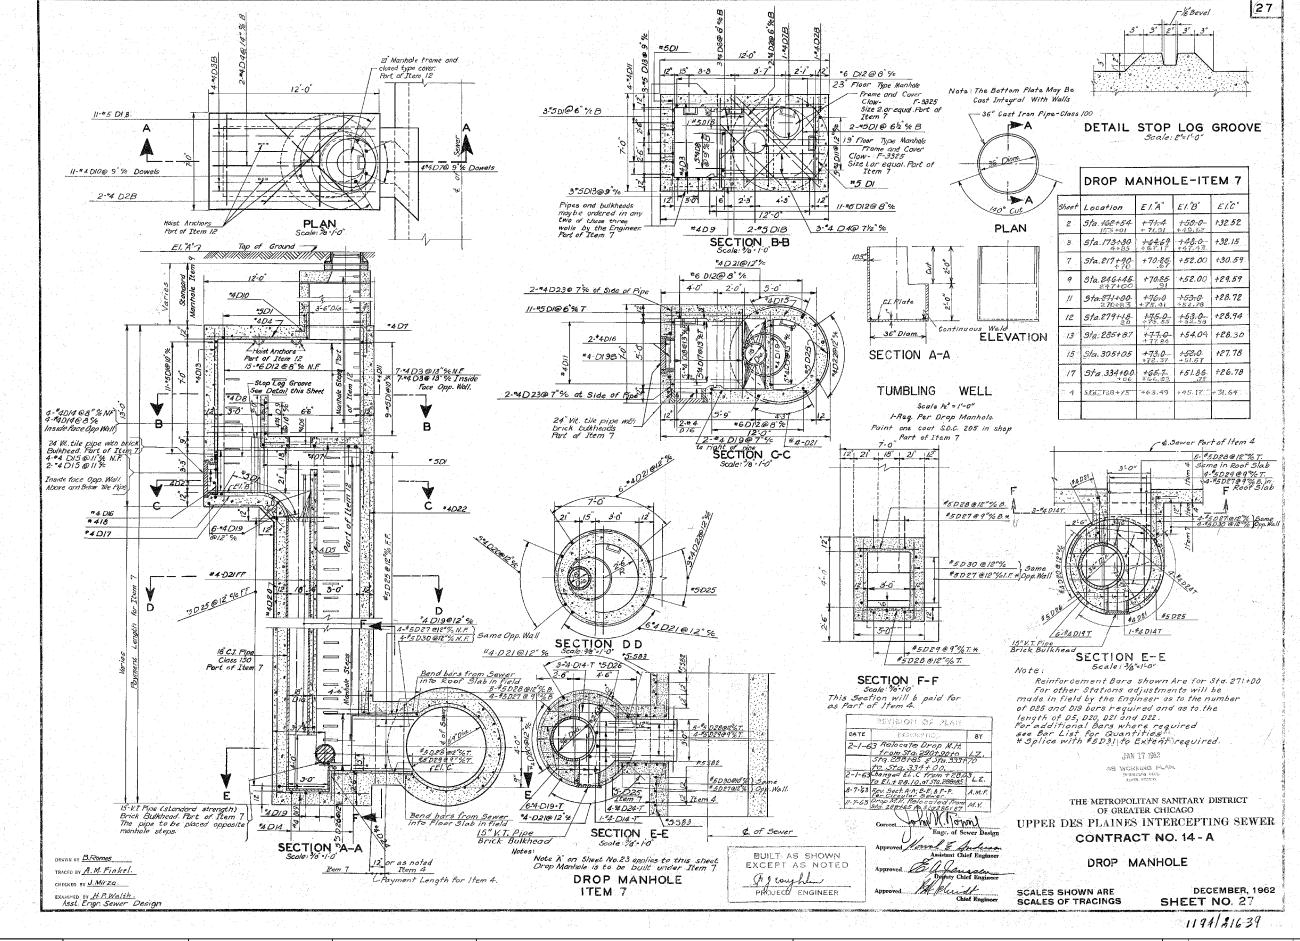VILLAGE OF MOUNT PROSPECT


SCALE: N.T.S.

FAIRVIEW GRAVITY SEWER
REFERENCE DRAWINGS

RTE. SECTION COUNTY TOTAL SHEETS NO.

COOK 47 46

CONTRACT NO21782.01

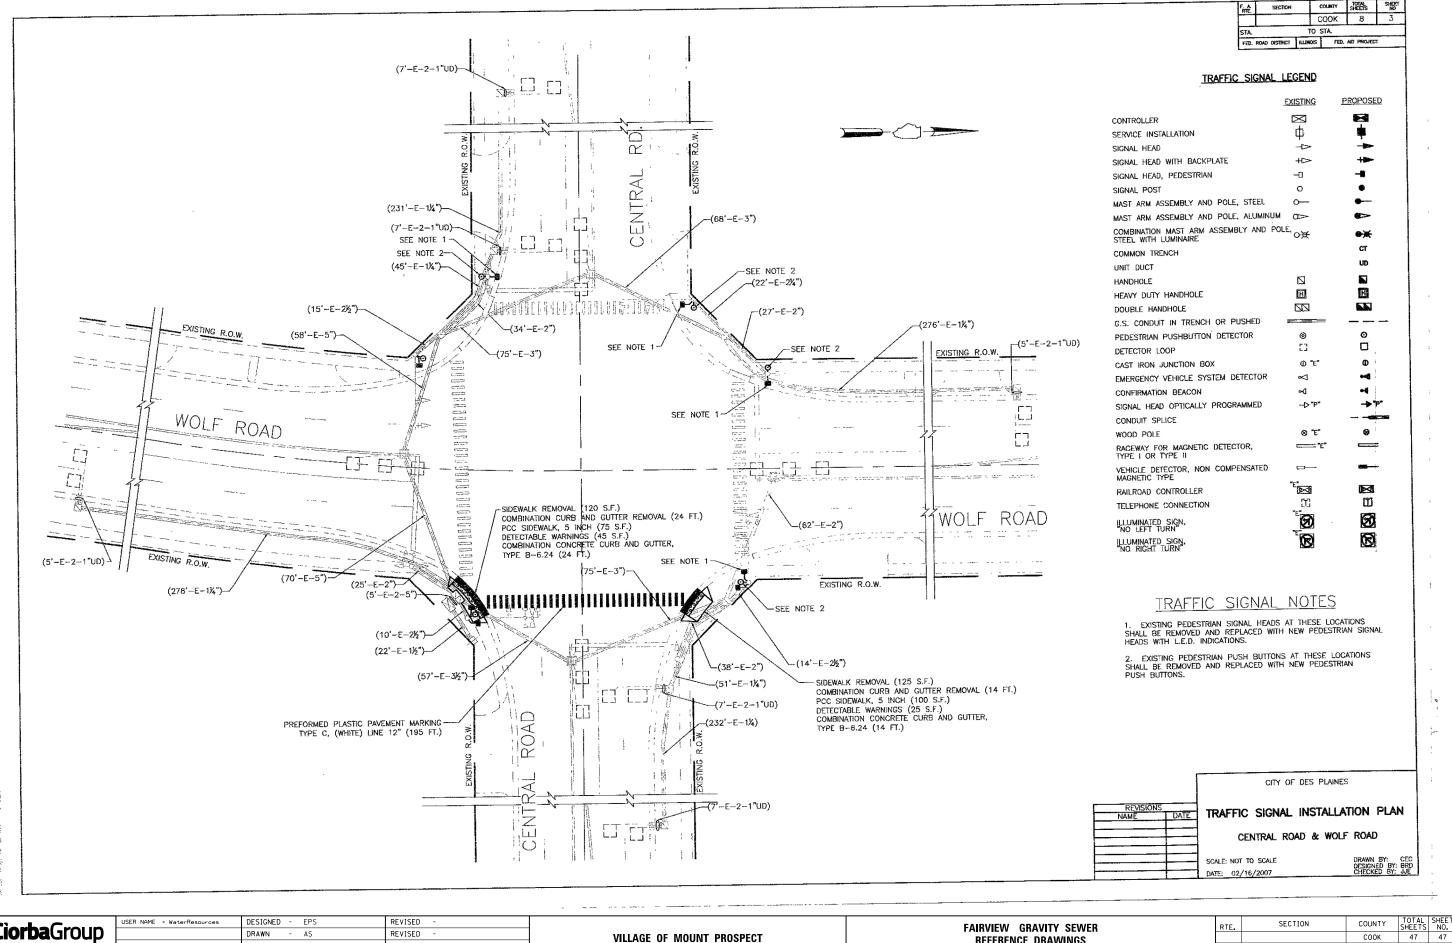

CiorbaGroup

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USER NAME = WaterResources	DESIGNED	-	EPS	REVISED -
	DRAWN	-	AS	REVISED -
PLOT SCALE = 2.0000 ' / in.	CHECKED	-	EPS	REVISED -
PLOT DATE = 2/16/2024	DATE	-	2/18/2024	REVISED -

VILLAGE OF MOUNT PROSPECT

SCALE: N.T.S.

FAIRVIEW GRAVITY SEWER									RTE.	SECTION	
REFERENCE DRAWINGS											
SHEET	NO.	3	OF	3	SHEETS	STA.	-	TO STA.	-		ILLINOIS FED. AI

COUNTY

COOK

CONTRACT NO21782.01